

GIS REGISTRY INFORMATION

SITE NAME:	Sunset Union 76			FID #	
BRRTS #:	03-68-100717		(if appropriate):		
COMMERCE # <small>(if appropriate):</small>	53186-7467-61				
CLOSURE DATE:	October 11, 2002				
STREET ADDRESS:	461 W Sunset Dr				
CITY:	Waukesha				
SOURCE PROPERTY GPS COORDINATES <small>(meters in WTM91 projection):</small>	X =	663758	Y =	280991	
CONTAMINATED MEDIA:	Groundwater	<input type="checkbox"/>	Soil	<input type="checkbox"/>	Both <input checked="" type="checkbox"/>
OFF-SOURCE GW CONTAMINATION >ES:	Yes	<input type="checkbox"/>	No	<input checked="" type="checkbox"/>	
• IF YES, STREET ADDRESS:					
• GPS COORDINATES <small>(meters in WTM91 projection):</small>					
	X =		Y =		
OFF-SOURCE SOIL CONTAMINATION >Generic or Site-Specific RCL (SSRCL):	Yes	<input type="checkbox"/>	No	<input checked="" type="checkbox"/>	
• IF YES, STREET ADDRESS 1:					
• GPS COORDINATES <small>(meters in WTM91 projection):</small>					
	X =		Y =		
CONTAMINATION IN RIGHT OF WAY:	Yes	<input type="checkbox"/>	No	<input checked="" type="checkbox"/>	
<u>DOCUMENTS NEEDED</u>					
Closure Letter, and any conditional closure letter issued					<input checked="" type="checkbox"/>
Copy of most recent deed, including legal description, for all affected properties					<input checked="" type="checkbox"/>
Certified survey map or relevant portion of the recorded plat map <i>(if referenced in the legal description)</i> for all affected properties					<input type="checkbox"/>
County Parcel ID number, <i>if used for county</i> , for all affected properties					<input checked="" type="checkbox"/>
Location Map which outlines all properties within contaminated site boundaries on USGS topographic map or plat map in sufficient detail to permit the parcels to be located easily (8.5x14" if paper copy). If groundwater standards are exceeded, the map must also include the location of all municipal and potable wells within 1200' of the site.					<input checked="" type="checkbox"/>
Detailed Site Map(s) for all affected properties , showing buildings, roads, property boundaries, contaminant sources, utility lines, monitoring wells and potable wells. (8.5x14", if paper copy) This map shall also show the location of all contaminated public streets, highway and railroad rights-of-way in relation to the source property and in relation to the boundaries of groundwater contamination exceeding ch. NR 140 ESs and soil contamination exceeding ch. NR 720 generic or SSRCLs.					<input checked="" type="checkbox"/>
Tables of Latest Groundwater Analytical Results (no shading or cross-hatching)					<input checked="" type="checkbox"/>
Tables of Latest Soil Analytical Results (no shading or cross-hatching)					<input checked="" type="checkbox"/>
Isoconcentration map(s), <i>if required for site investigation (SI)</i> (8.5x14" if paper copy). The isoconcentration map should have flow direction and extent of groundwater contamination defined. If not available, include the latest extent of contaminant plume map.					<input checked="" type="checkbox"/>
GW: Table of water level elevations, with sampling dates, and free product noted if present					<input checked="" type="checkbox"/>
GW: Latest groundwater flow direction/monitoring well location map (should be 2 maps if maximum variation in flow direction is greater than 20 degrees)					<input checked="" type="checkbox"/>
SOIL: Latest horizontal extent of contamination exceeding generic or SSRCLs, with one contour					<input type="checkbox"/>
Geologic cross-sections, <i>if required for SI</i> . (8.5x14' if paper copy)					<input checked="" type="checkbox"/>
RP certified statement that legal descriptions are complete and accurate					<input checked="" type="checkbox"/>
Copies of off-source notification letters (if applicable)					<input type="checkbox"/>
Letter informing ROW owner of residual contamination (if applicable)(public, highway or railroad ROW)					<input type="checkbox"/>
Copy of (soil or land use) deed restriction(s) or deed notice <i>if any required as a condition of closure</i>					<input type="checkbox"/>



October 11, 2002

Mr. Ben Burrie
Scott Oil Company, Inc.
461 Sunset Dr.
PO Box 586
Waukesha, WI 53187-0586

RE: **Final Closure**

Commerce # 53186-7467-61 **WDNR BRRTS # 03-68-100717**
Sunset Union 76, 461 W. Sunset Drive, Waukesha

Dear Mr. Burrie:

The Wisconsin Department of Commerce (Commerce) has received all items required for closure of the site referenced above. This site is now listed as "closed" on the Commerce database and will be included on the Wisconsin Department of Natural Resources (WDNR) Geographic Information System (GIS) Registry of Closed Remediation Sites to address residual contamination.

It is in your best interest to keep all documentation related to the environmental activities at your site. If residual contamination is encountered in the future, appropriate measures must be implemented to assure that it is managed following all applicable regulations. If future site conditions indicate that any remaining contamination poses a threat, and subsequent information indicates a need to reopen this case, any original claim under the PECFA fund would also reopen and you may apply for assistance to the extent of remaining eligibility.

Thank you for your efforts to protect Wisconsin's environment. If you have any questions, please contact me in writing at the letterhead address or by telephone at (414) 220-5375.

Sincerely,

A handwritten signature in black ink that reads 'Greg Michael'. The signature is written in a cursive, flowing style.

Greg Michael
Hydrogeologist
Site Review Section

cc: Moraine Environmental Services, inc.
Case File



AUG 14 00 00 07 55

2583113
REGISTER'S OFFICE
WAUKESHA COUNTY, WI
RECORDED ON

08-14-2000 2:31 PM

MICHAEL J. HASSLINGER
REGISTER OF DEEDS

REC. FEE: 4.00
REC. FEE-CO: 4.00
REC. FEE-ST: 2.00
TRAN. FEE:
TRAN. FEE-STATE:
PAGES: 1

Sara J. Liszewski
as Personal Representative of the estate of Nettie Ann Warren

("Decedent"), for a valuable consideration conveys, without warranty, to Scott D. Warren

Grantee, the following described real estate in Waukesha County, State of Wisconsin (hereinafter called the "Property");

All that part of Block 16, Sunset Heights Addition No. 1, being a recorded subdivision of part of the Northwest 1/4 of the Northeast 1/4 of Section 15, Town 6 North, Range 19 East, City of Waukesha, County of Waukesha, State of Wisconsin, bounded and described as follows: Beginning at the Northwest corner of said Block 16; thence North 88°21' East along the Northerly line of said Block 16, 180.00 feet; thence Due South parallel to the West line of said

Block 16, 175.00 feet; thence South 88°21' West, parallel to the North line of said Block 16, 180.00 feet to the West line of said Block 16; thence Due North along said West line, 175.00 feet to the place of beginning.

Excepting an easement of ingress and egress in common with others over the above described premises, bounded and described as follows:

Beginning at a point at the Northeast corner of the above described premises; thence South 88°21' West 20 feet along the North line of said premises to a point; thence South 50 feet parallel to the East line of the aforesaid premises; thence East 20 feet to the aforesaid East line; and thence North along the East line of the aforesaid premises to the point of beginning.

The grantors further grant an easement, in common with others, as follows: Beginning at a point at the Northeast corner of the above described premises; thence North 88°21' East 20 feet along the North line of grantors' adjoining premises; thence South 50 feet along a line parallel to the East line of the premises described above; thence West 20 feet along a line parallel to the aforesaid North line; thence North to the point of beginning.

This deed is given in fulfillment of a Land Contract by and between Nettie Ann Warren, Deceased ("Vendor"), and Scott Warren ("Purchaser") dated February 2, 1999, and recorded in office of Waukesha County Register of Deeds on September 30, 1999 as Document No. 2507156.

Nettie Ann Warren ("Vendor") died on October 15, 1999 and her estate is being probated in the Circuit Court for Waukesha County, Wisconsin, Probate Division, as File No. 99IN0589.

Personal Representative by this deed does convey to Grantee all of the estate and interest in the Property which the Decedent had immediately prior to Decedent's death, and all of the estate and interest in the Property which the Personal Representative has since acquired.

Dated this 12th day of July, 2000

FEE # 7725(17)
EXEMPT

NETTIE ANN WARREN ESTATE

• Sara J. Liszewski

Personal Representative

Personal Representative
AUTHENTICATION

Signature(s) of Sara J. Liszewski

authenticated this 12 day of July, 2000

• Philip J. Remmers, Esq.

TITLE: MEMBER STATE BAR OF WISCONSIN

(If not authorized by § 1109.09, Wis. Stat.)

THIS INSTRUMENT WAS DRAFTED BY

Philip J. Remmers, Esq.
Waukesha, WI 53186

(Signatures may be authenticated or acknowledged. Both are not necessary.)

ACKNOWLEDGMENT

STATE OF WISCONSIN)

) ss.
County.)

Personally came before me this _____ day of _____, _____ the above named

to me known to be the person(s) who executed the foregoing instrument and acknowledge the same.

Notary Public, State of Wisconsin
My Commission is permanent. (If not, state expiration date: _____)

*Names of persons signing in any capacity should be typed or printed below their signatures

Make Check Payable to:

City of Waukesha

Important: Correspondence should refer to tax number.
See reverse side for important information.

Be sure this description covers your property. This description is
for property tax bill only and may not be a full legal description

461 W SUNSET DR

PT BLK 16 SUNSET HEIGHTS AD

D NO 1 PT NE1/4 SEC 15 T6N

R19E BEG NW COR, N88 21'E
ON N LI 180', S PARA W LI



SCOTT WARREN

C/O SCOTT OIL CO INC

P O BOX 586

WAUKESHA WI 53187



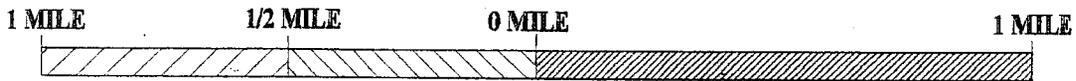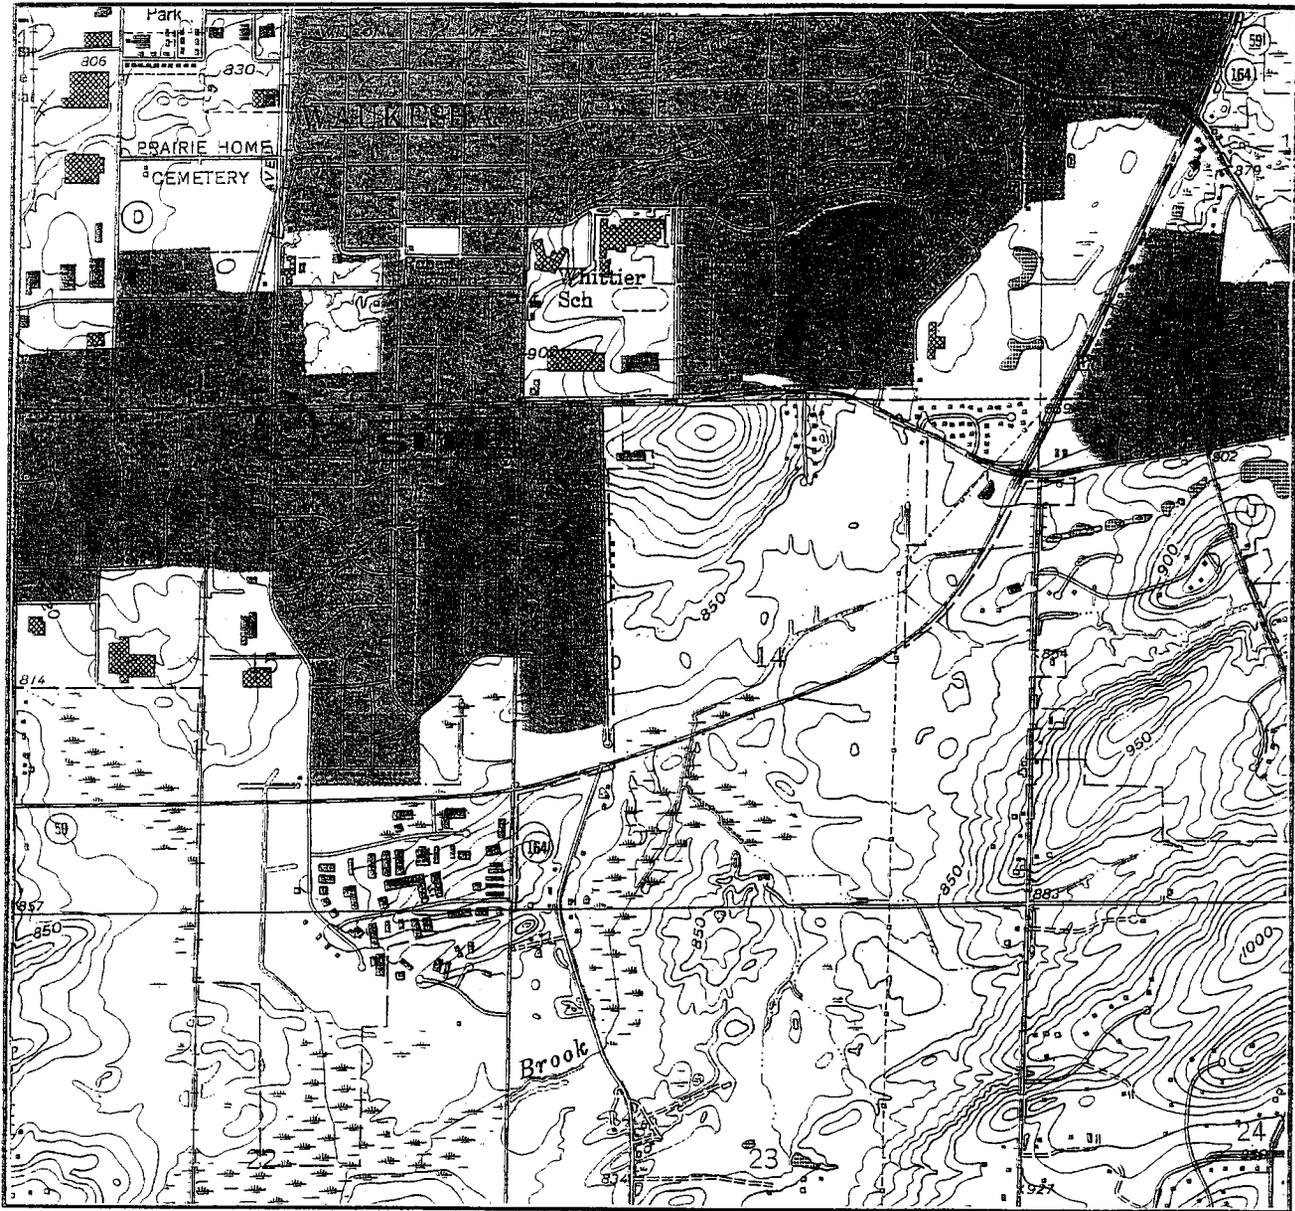


UTM Coordinates: 663748, 280980

○ — SITE LOCATION

SCALE 1:24,000

Site Location Map		
Sunset Shell Station 461 W. Sunset Drive Waukesha, Wisconsin		
1517	Moraine Environmental, Inc.	
1:24,000	11-8-01	Figure 1

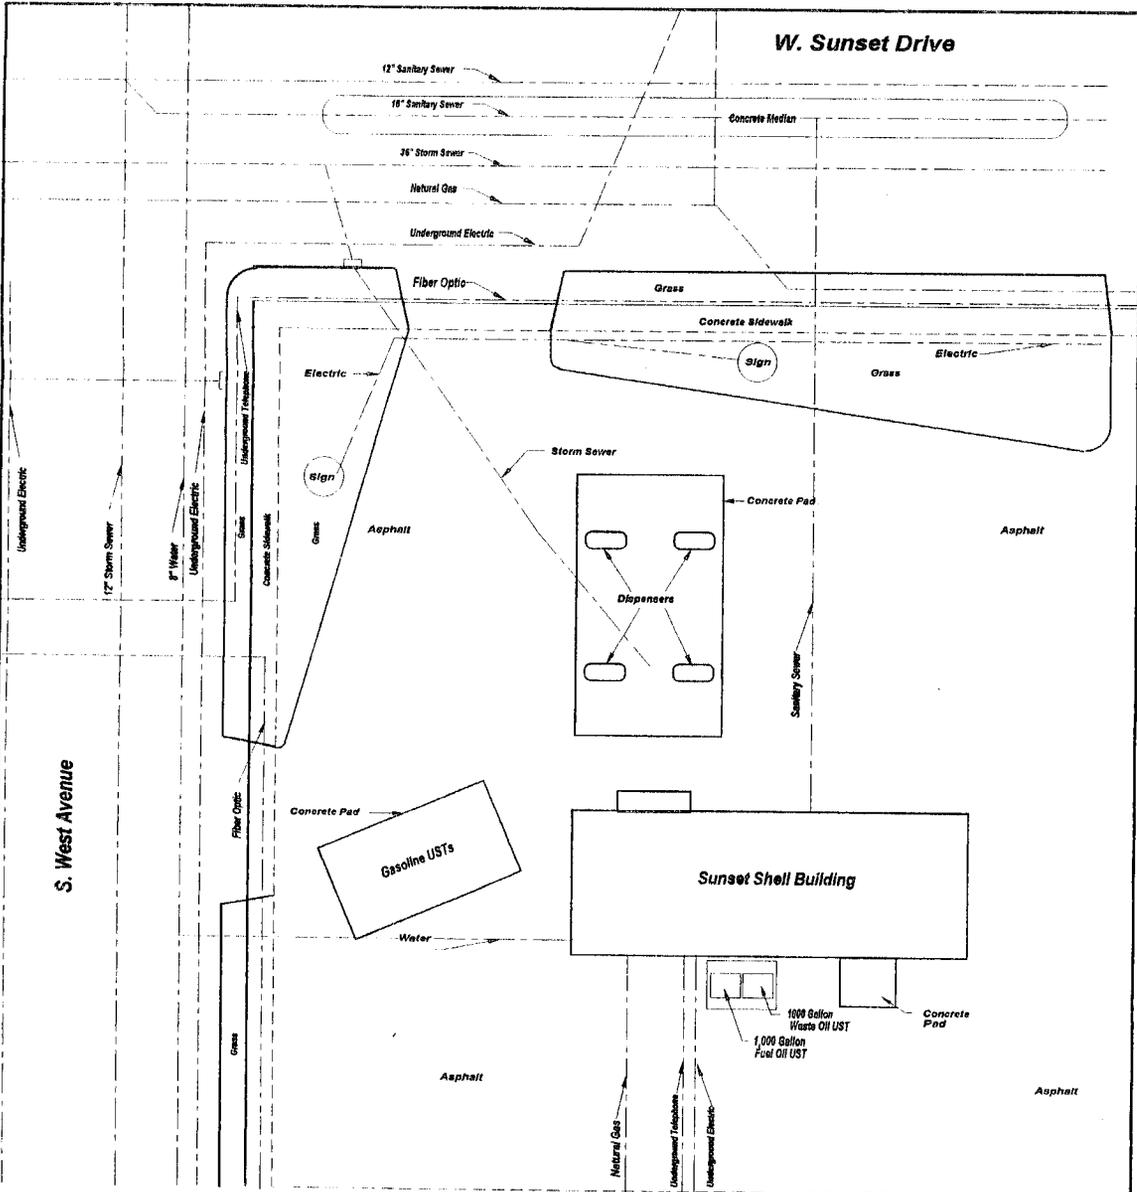


S. West Avenue

W. Sunset Drive

McDonalds Restaurant



Approximate Scale 1" = 30'

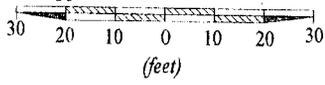

DRAWING TITLE			
Site Plan Map			
SITE LOCATION			
Sunset Shell Station 461 W. Sunset Drive Waukesha, WI			
PROJECT NUMBER	DATE OF DRAWING	DRAWING NAME	FIGURE NUMBER
15171	3-23-00	15171g4h	3

**TABLE 4
DETECTABLE GROUNDWATER QUALITY RESULTS
SUNSET SHELL
MEI Project #1517**

ANALYTE	MW1				MW2				MW3				MW4				MW5				NR 140	
	4/10/00	9/12/00	12/6/00	3/21/01	4/10/00	9/12/00	12/6/00	3/21/01	4/10/00	9/12/00	12/6/00	3/21/01	4/10/00	9/12/00	12/6/00	3/21/01	4/10/00	9/12/00	12/6/00	3/21/01	ES	PAL
Benzene	<0.27	1.3	<0.35	<0.35	<0.27	<0.35	<0.35	<0.35	5.9	<0.35	1.2	2.3	270	32	18	11	<0.27	<0.35	<0.35	<0.35	5.0	0.5
s-Butylbenzene	<0.29	*	*	*	<0.29	*	*	*	0.58Q	*	*	*	17	*	*	*	<0.29	*	*	*	NSE	NSE
Ethylbenzene	<0.32	<0.37	<0.37	<0.37	<0.32	<0.37	<0.37	<0.37	1.7	<0.37	4.9	9.4	420	240	400	370	<0.32	<0.37	<0.37	<0.37	700	140
Gasoline Range Organics	<50	*	*	*	<50	*	*	*	190	*	*	*	12,000	*	*	*	<50	*	*	*	NSE	NSE
Isopropylbenzene	<0.26	*	*	*	<0.26	*	*	*	5.8	*	*	*	62	*	*	*	<0.26	*	*	*	NSE	NSE
p-Isopropyltoluene	<0.24	*	*	*	<0.24	*	*	*	<0.24	*	*	*	5.8Q	*	*	*	<0.24	*	*	*	NSE	NSE
Methyl-tert-butyl- ether	<0.32	5.2	0.88 Q	<0.36	<0.32	<0.36	<0.36	<0.36	22	30	26	1.6	<3.2	8.3	45	23	<0.32	<0.36	<0.36	<0.36	60	12
Lead, Soluble	4.9	1.9	45	0.41Q	1.1	1.1	14	0.33Q	1.1	10	1.1	<0.18	<0.92	1.6	1.3	0.23Q	<0.92	2.7	7.2	0.61	15	1.5
Naphthalene	<0.35	<0.44	<0.44	<0.44	<0.35	<0.44	<0.44	<0.44	<0.35	<0.44	<0.44	<0.44	220	160	240	180	<0.35	<0.44	<0.44	<0.44	40	8
n-Propylbenzene	<0.76	*	*	*	<0.76	*	*	*	2.6	*	*	*	180	*	*	*	<0.76	*	*	*	NSE	NSE
Toluene	0.34Q	0.39Q	<0.38	<0.38	0.65Q	<0.38	<0.38	<0.38	0.54Q	<0.38	1.7	0.63Q	69	9.9	18	21	<0.27	<0.38	<0.38	<0.38	1,000	200
Trimethylbenzenes	<0.27	<0.37	<0.37	<0.37	0.35Q	<0.37	<0.37	<0.37	<0.27	<0.37	0.46 Q	1.2	1,950	670	1,150	1,013	<0.27	<0.37	<0.37	<0.37	480	96
Xylenes	<0.43	<0.76	<0.76	<0.76	0.84Q	<0.76	<0.76	<0.76	<0.43	<0.76	1.7 Q	2.3Q	1,770	411	900	870	<0.43	<0.76	<0.76	<0.76	10,000	1,000

Key:

* - Not Analyzed

All Results Are Expressed in Micrograms/Liter

Q - Results Are Qualified Due To The Uncertainty of the Parameter Concentration Between The Limit Of Detection (LOD) and the Limit of Quantification (LOQ).

NSE = No Standard Established

NR 140 = Wisconsin Administrative Code Groundwater Quality Standards

ES = Enforcement Standards

PAL = Preventive Action Limits

BOLD and shaded box exceeds ES

Bold type exceeds PAL

TABLE 3
SUNSET SHELL STATION
SOIL QUALITY RESULTS - DETECTABLE ONLY
FEBRUARY 10 & 11 and March 23, 2000

~ 10' ▽ B6.5

ANALYTE	B1	B1	B1	B2	B2	B3	B3	B4	B4	B5	B5	NR 720 RCL
	2-4'	6-8'	14-16'	8-10'	16-18'	10-12'	16-18'	12-14'	14-16'	12-14'	18-20'	
Diesel Range Organics (DRO)	<4.4	*	<4.1	<3.8	<5.0	<4.0	<4.0	*	*	*	*	100
Gasoline Range Organics (GRO)	*	*	*	*	*	*	*	<2.7	<2.7	<2.7	<2.7	100
Cadmium	0.15 Q	*	<0.071	<0.068 Q	0.1 Q	0.098 Q	0.39	*	*	*	*	8
Lead	4.8	*	2.4	2.8	2.6	3.4	3.2	4.1	3.6	4.0	4.7	50
Benzene	<25	*	<25	<25	<25	<25	<25	<25	<25	<25	<25	5.5
s-Butylbenzene	<25	*	<25	<25	<25	<25	<25	<25	<25	<25	<25	NSE
Ethylbenzene	<25	*	42	<25	<25	<25	<25	<25	<25	<25	<25	2900
Fluoranthene	*	24Q	*	*	*	*	*	*	*	*	*	NSE
Isopropylbenzene	<25	*	<25	<25	<25	<25	<25	<25	<25	<25	<25	NSE
p-Isopropyltoluene	<25	*	<25	<25	<25	<25	<25	<25	<25	<25	<25	NSE
Methyl-tert-butyl-ether	<25	*	<25	33Q	28Q	30Q	<25	<25	<25	<25	<25	NSE
Naphthalene	<25	<16	<25	<25	<25	<25	<25	<25	<25	<25	<25	NSE
n-Propylbenzene	<25	*	<25	<25	<25	<25	<25	<25	<25	<25	<25	NSE
Phenanthrene	*	18Q	*	*	*	*	*	*	*	*	*	NSE
Pyrene	*	20Q	*	*	*	*	*	*	*	*	*	NSE
1,2,4-Trimethylbenzene	<25	*	<25	<25	<25	<25	<25	<25	<25	<25	<25	NSE
1,3,5-Trimethylbenzene	<25	*	<25	<25	<25	<25	<25	<25	<25	<25	<25	NSE
Xylenes	<25	*	134	<25	<25	<25	<25	<25	<25	<25	<25	4100

Notes:

Bold type identifies NR 720 RCL exceedence

* - Not Analyzed

RCL - Residual Contaminant Level

Q - Result is qualified due to the uncertainty of the parameter concentration between the Limit of Detection (LOD) and the Limit of Quantification (LOQ).

NSE - No Standard Established

Other than Diesel Range Organics, Gasoline Range Organics, Cadmium and Lead (Expressed in Mg/kg), all results are expressed in ug/kg.

Soil borings B15, B18 and B19 were blind drilled, no soil samples were taken.

TABLE 3 (cont)
SUNSET SHELL STATION
SOIL QUALITY RESULTS - DETECTABLE ONLY
FEBRUARY 10 & 11 AND MARCH 23, 2000

~ 10' ▽ 365

ANALYTE	B6	B6	B7	B7	B8	B8	B9	B9	B10	B10	NR 720 RCL
	10-12'	16-18'	10-12'	18-20'	12-14'	16-18'	6-8'	14-16'	4-6'	14-16'	
Diesel Range Organics (DRO)	*	*	*	*	*	*	*	*	*	*	100
Gasoline Range Organics (GRO)	35	9.0	<2.7	<2.9	23	12	<2.7	<2.7	<2.7	<2.7	100
Cadmium	*	*	*	*	*	*	*	*	*	*	8
Lead	3.9	1.7	3.8	1.8	3.5	3.1	4.5	1.9	3.7	2.0	50
Benzene	<25	32	<25	<25	<25	<25	<25	<25	<25	<25	5.5
s-Butylbenzene	99	<25	<25	<25	100	92	<25	<25	<25	<25	NSE
Ethylbenzene	<25	100	<25	<25	580	1200	<25	<25	<25	<25	2900
Fluoranthene	*	*	*	*	*	*	*	*	*	*	NSE
Isopropylbenzene	<25	<25	<25	<25	180	200	<25	<25	<25	<25	NSE
p-Isopropyltoluene	41 Q	<25	<25	<25	47	44Q	<25	<25	<25	<25	NSE
Methyl-tert-butyl-ether	<25	<25	<25	<25	<25	<25	<25	<25	<25	<25	NSE
Naphthalene	86	260	<25	<25	920	1200	<25	<25	<25	<25	NSE
n-Propylbenzene	80	150	<25	<25	980	1100	<25	<25	<25	<25	NSE
Phenanthrene	*	*	*	*	*	*	*	*	*	*	NSE
Pyrene	*	*	*	*	*	*	*	*	*	*	NSE
1,2,4-Trimethylbenzene	310	1000	<25	<25	5400	5800	<25	<25	<25	<25	NSE
1,3,5-Trimethylbenzene	150	320	<25	<25	1600	1200	<25	<25	<25	<25	NSE
Xylenes	29	446	70	<25	1700	3340	<25	<25	<25	<25	4100

Notes:

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Q - Result is qualified due to the uncertainty of the parameter concentration between the Limit of Detection (LOD) and the Limit of Quantification (LOQ).

NSE - No Standard Established

Other than Diesel Range Organics, Gasoline Range Organics, Cadmium and Lead (Expressed in Mg/kg), all results are expressed in ug/kg.

Soil borings B15, B18 and B19 were blind drilled, no soil samples were taken.

TABLE 3 (cont)
SUNSET SHELL STATION
SOIL QUALITY RESULTS - DETECTABLE ONLY
FEBRUARY 10 & 11 AND MARCH 23, 2000

ANALYTE	B11	B11	B12	B12	B13	B13	B14	B14	B16	B16	B17	B17	NR 720 RCL
	4-6'	14-16'	2-4'	16-18'	10-12'	14-16'	12-14'	14-16'	2-4'	6-8'	4-6'	8-10'	
Diesel Range Organics (DRO)	*	*	*	*	*	*	*	*	*	*	*	*	100
Gasoline Range Organics (GRO)	<2.8	3.0	<3.1	<2.8	<2.7	<2.8	<2.7	<2.7	*	*	*	*	100
Cadmium	*	*	*	*	*	*	*	*	*	*	*	*	8
Lead	3.2	2.6	10	1.8	4.1	2.5	3.5	3.5	*	*	*	*	50
Benzene	<25	<25	<25	<25	<25	<25	<25	<25	<25	<25	<25	<25	5.5
s-Butylbenzene	<25	<25	<25	<25	<25	<25	<25	<25	*	*	*	*	NSE
Ethylbenzene	<25	210	<25	50 Q	<25	100	<25	<25	<25	<25	<25	<25	2900
Fluoranthene	*	*	*	*	*	*	*	*	*	*	*	*	NSE
Isopropylbenzene	<25	<25	<25	<25	<25	<25	<25	<25	*	*	*	*	NSE
p-Isopropyltoluene	<25	<25	<25	<25	<25	<25	<25	<25	*	*	*	*	NSE
Methyl-tert-butyl-ether	*	*	<25	<25	<25	<25	<25	<25	<25	<25	<25	<25	NSE
Naphthalene	<25	92	350	<25	<25	<25	<25	<25	*	*	*	*	NSE
n-Propylbenzene	<25	61	<25	<25	<25	49 Q	<25	<25	*	*	*	*	NSE
Phenanthrene	*	*	*	*	*	*	*	*	*	*	*	*	NSE
Pyrene	*	*	*	*	*	*	*	*	*	*	*	*	NSE
1,2,4-Trimethylbenzene	<25	320	<25	48	<25	<25	<25	<25	<25	<25	<25	<25	NSE
1,3,5-Trimethylbenzene	<25	57	<25	30 Q	<25	<25	<25	<25	<25	<25	<25	<25	NSE
Xylenes	<25	588	<25	<25	<25	<25	<25	<25	<25	<25	<25	<25	4100

Notes:

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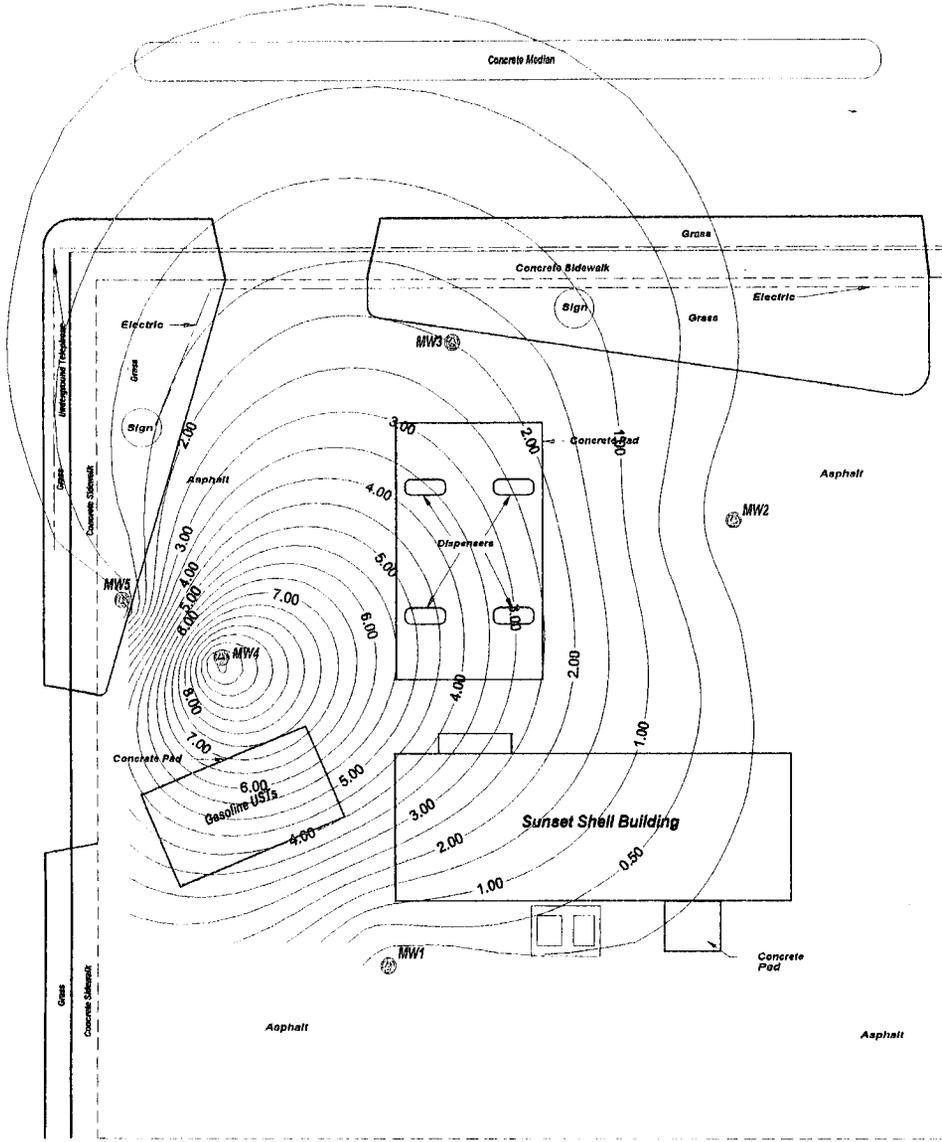
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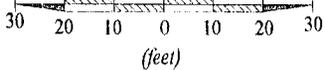
W. Sunset Drive

S. West Avenue



McDonalds Restaurant

Approximate Scale 1" = 30'




DRAWING TITLE			
Iso - Concentration Map For Benzene In Groundwater			
March 21, 2001 Data			
SITE LOCATION			
Sunset Shell Station			
461 W. Sunset Drive			
Waukesha, WI			
PROJECT NUMBER	DATE OF DRAWING	DRAWING NAME	FIGURE NUMBER
1517i	3-23-00	1517fg4a	17

Table 2
Static Water Level - Measurements / Groundwater Elevations
Sunset Shell Station
461 West Sunset Drive, Waukesha, WI
Project #1517

Monitoring Well I.D.	Elevation of TOC	Depth to Water (Ft. Below TOC)	Groundwater Elevation
MW1			
4/7/00	99.16'	13.77'	85.39'
9/12/00	99.16'	10.92'	88.24'
12/6/00	99.16'	11.51'	87.65'
3/21/01	99.16'	11.31'	87.85'
MW2			
4/7/00	98.21'	12.86'	85.35'
9/12/00	98.21'	9.97'	88.24'
12/6/00	98.21'	10.60'	87.61'
3/21/01	98.21'	10.36'	87.85'
MW3			
4/7/00	96.95'	11.58'	85.37'
9/12/00	96.95'	8.70'	88.25'
12/6/01	96.95'	9.33'	87.62'
3/21/01	96.95'	9.02'	87.93'
MW4			
4/7/00	98.34'	13.01'	85.33'
9/12/00	98.34'	10.13'	88.21'
12/6/00	98.34'	10.71'	87.63'
3/21/01	98.34'	10.47'	87.87'
MW5			
4/7/00	98.45'	13.12'	85.33'
9/12/00	98.45'	10.22'	88.23'
12/6/00	98.45'	10.82'	87.63'
3/21/01	98.45'	10.58'	87.87'



W. Sunset Drive

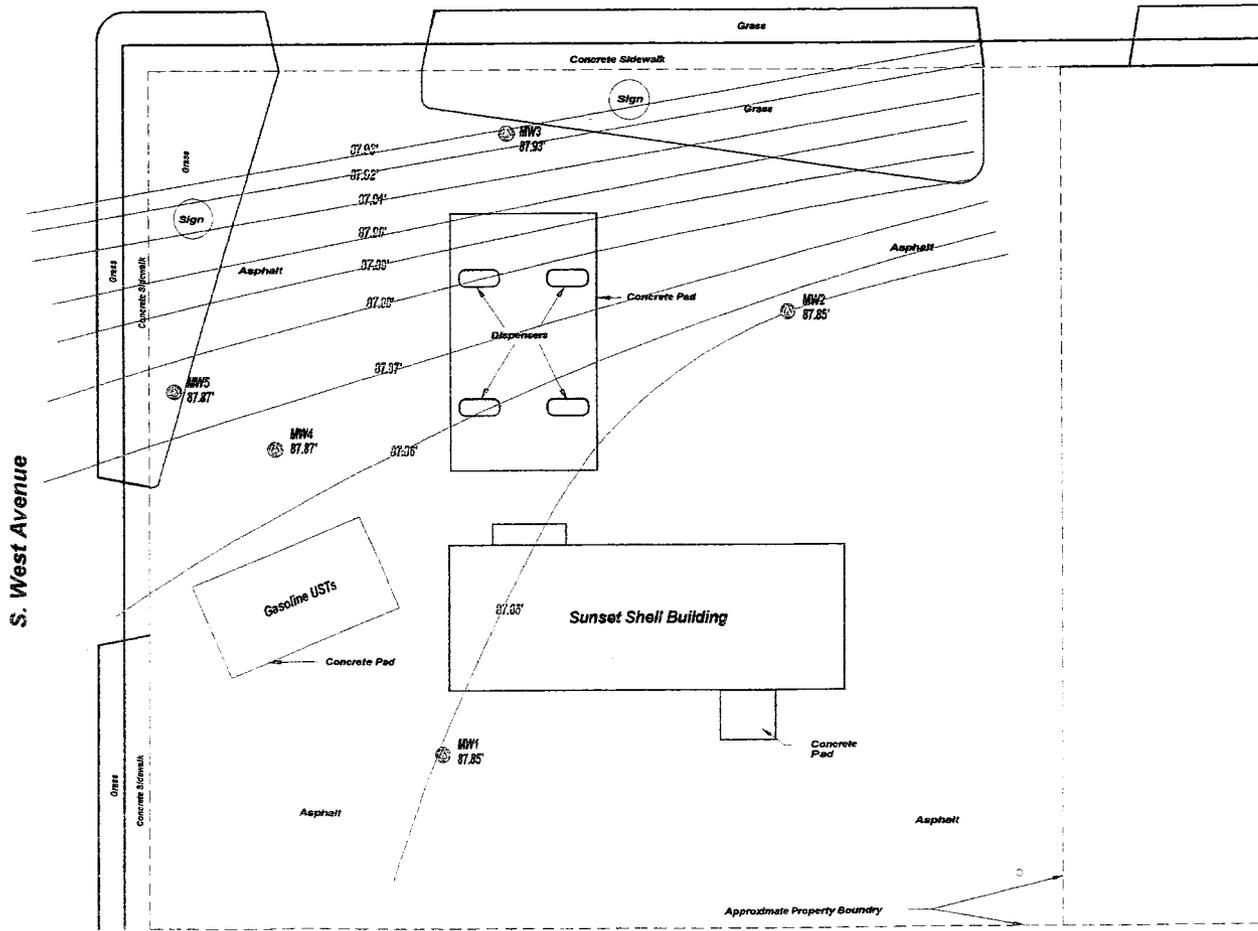


Groundwater Monitoring Well Location



Pizze Hut Restaurant

Site Feature Locations Are Approximate. Site Has Not Been Surveyed.

McDonalds Restaurant

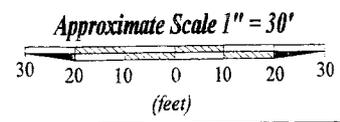


DRAWING TITLE			
Groundwater Elevation Map			
March 21, 2001 Data			
SITE LOCATION			
Sunset Shell Station 461 W. Sunset Drive Waukesha, WI			
PROJECT NUMBER	DATE OF DRAWING	DRAWING NAME	FIGURE NUMBER
1517i	10-4-01	1517fg1r	13

W. Sunset Drive




S. West Avenue

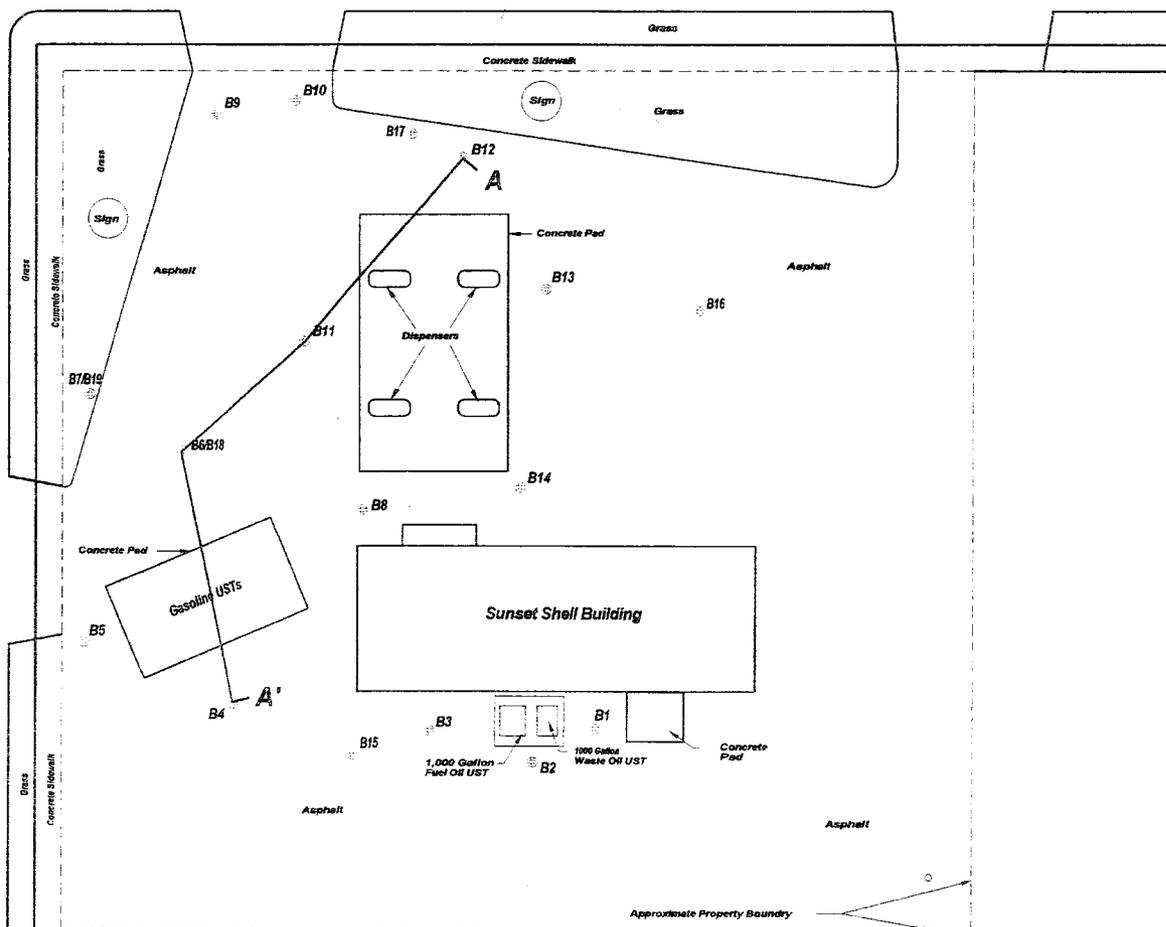

Approximate Soil Boring Location

Pizza Hut Restaurant

McDonalds Restaurant

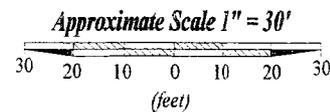

DRAWING TITLE			
Columnar Cross-Sectional Location Map			
SITE LOCATION			
Sunset Shell Station 461 W. Sunset Drive Waukesha, WI			
PROJECT NUMBER	DATE OF DRAWING	DRAWING NAME	FIGURE NUMBER
1517	9-14-01	1517kg1x	9


NORTH

HORIZONTAL SCALE 1" = 30'

SOUTH

A

A'

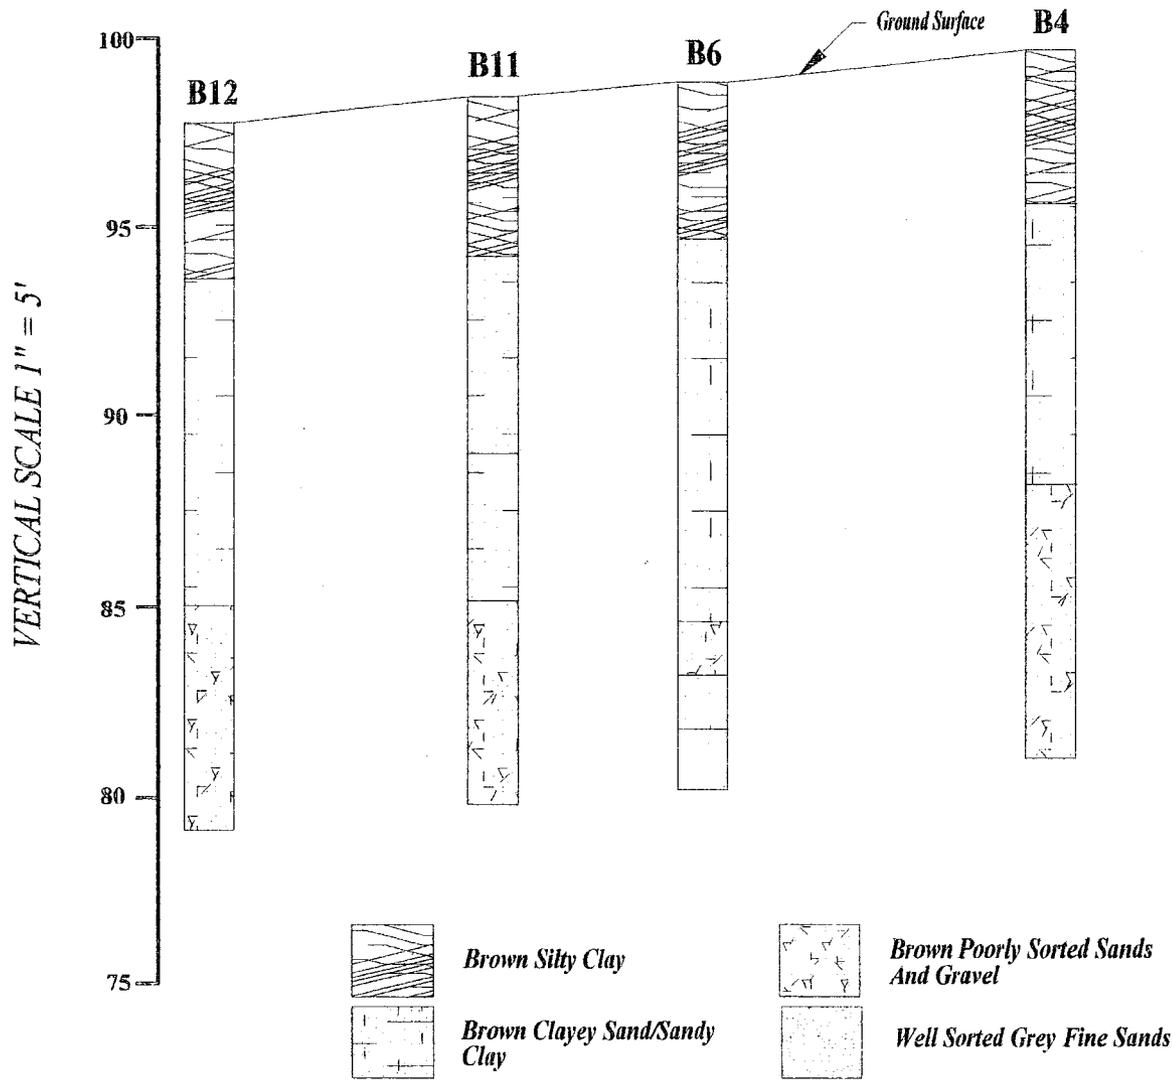

Generalized Soil Conditions Are Illustrated. Refer To Soil Boring Logs For Detailed Soil Conditions

Columnar Cross Section A - A'

Sunset Shell Station
461 W. Sunset Drive
Waukesha, Wisconsin

9-14-01

#1517

FIGURE 8

March 29, 2002

Mr. Greg Michael
Wisconsin Department of Commerce
Environmental & Regulatory Services
101 Pleasant Street, Suite #100A
Milwaukee WI 53212-3963

RE: **Sunset Union 76**
461 W. Sunset Drive, Waukesha WI 53186
BRRTS #03-68-100717/PECFA #53186-7467-61

Project #1517

To Whom It May Concern:

I certify that, to the best of my knowledge, the legal description attached to this statement is complete, accurate, and describes the correct contaminated property site.

If you should have any questions, please do not hesitate to contact me, or my consultant, Moraine Environmental at (262) 377-9060.

Sincerely,



Ben Burrie
Scott Oil Company, Inc.

Enc.