

GIS REGISTRY INFORMATION

| | | | | | |
|--|--------------------------|--------------------------|------------|-------------------------------------|--|
| SITE NAME: | Third Street Parking Lot | | | FID # | |
| BRRTS #: | 03-28-390478 | | | (if appropriate): | |
| COMMERCE # (if appropriate): | 53094-3719-18 | | | | |
| CLOSURE DATE: | May 4, 2005 | | | | |
| STREET ADDRESS: | 118 N 3rd St | | | | |
| CITY: | Watertown | | | | |
| SOURCE PROPERTY GPS COORDINATES (meters in WTM91 projection): | X = | 623800 | Y = | 303235 | |
| CONTAMINATED MEDIA: | Groundwater | <input type="checkbox"/> | Soil | <input type="checkbox"/> | Both <input checked="" type="checkbox"/> |
| OFF-SOURCE GW CONTAMINATION >ES: | Yes | <input type="checkbox"/> | No | <input checked="" type="checkbox"/> | |
| • IF YES, STREET ADDRESS: | | | | | |
| • GPS COORDINATES (meters in WTM91 projection): | | | | | |
| | X = | | Y = | | |
| OFF-SOURCE SOIL CONTAMINATION >Generic or Site-Specific RCL (SSRCL): | Yes | <input type="checkbox"/> | No | <input checked="" type="checkbox"/> | |
| • IF YES, STREET ADDRESS 1: | | | | | |
| • GPS COORDINATES (meters in WTM91 projection): | | | | | |
| | X = | | Y = | | |
| CONTAMINATION IN RIGHT OF WAY: | Yes | <input type="checkbox"/> | No | <input checked="" type="checkbox"/> | |
| <u>DOCUMENTS NEEDED</u> | | | | | |
| Closure Letter, and any conditional closure letter issued | | | | | <input checked="" type="checkbox"/> |
| Copy of most recent deed, including legal description, for all affected properties | | | | | <input checked="" type="checkbox"/> |
| Certified survey map or relevant portion of the recorded plat map (if referenced in the legal description) for all affected properties | | | | | <input type="checkbox"/> |
| County Parcel ID number, if used for county, for all affected properties | | | | | <input checked="" type="checkbox"/> |
| Location Map which outlines all properties within contaminated site boundaries on USGS topographic map or plat map in sufficient detail to permit the parcels to be located easily (8.5x14" if paper copy). If groundwater standards are exceeded, the map must also include the location of all municipal and potable wells within 1200' of the site. | | | | | <input checked="" type="checkbox"/> |
| Detailed Site Map(s) for all affected properties, showing buildings, roads, property boundaries, contaminant sources, utility lines, monitoring wells and potable wells. (8.5x14", if paper copy) This map shall also show the location of all contaminated public streets, highway and railroad rights-of-way in relation to the source property and in relation to the boundaries of groundwater contamination exceeding ch. NR 140 ESs and soil contamination exceeding ch. NR 720 generic or SSRCLs. | | | | | <input checked="" type="checkbox"/> |
| Tables of Latest Groundwater Analytical Results (no shading or cross-hatching) | | | | | <input checked="" type="checkbox"/> |
| Tables of Latest Soil Analytical Results (no shading or cross-hatching) | | | | | <input checked="" type="checkbox"/> |
| Isoconcentration map(s), if required for site investigation (SI) (8.5x14" if paper copy). The isoconcentration map should have flow direction and extent of groundwater contamination defined. If not available, include the latest extent of contaminant plume map. | | | | | <input checked="" type="checkbox"/> |
| GW: Table of water level elevations, with sampling dates, and free product noted if present | | | | | <input checked="" type="checkbox"/> |
| GW: Latest groundwater flow direction/monitoring well location map (should be 2 maps if maximum variation in flow direction is greater than 20 degrees) | | | | | <input checked="" type="checkbox"/> |
| SOIL: Latest horizontal extent of contamination exceeding generic or SSRCLs, with one contour | | | | | <input checked="" type="checkbox"/> |
| Geologic cross-sections, if required for SI. (8.5x14" if paper copy) | | | | | <input checked="" type="checkbox"/> |
| RP certified statement that legal descriptions are complete and accurate. | | | | | <input checked="" type="checkbox"/> |
| Copies of off-source notification letters (if applicable) | | | | | <input type="checkbox"/> |
| Letter informing ROW owner of residual contamination (if applicable)(public, highway or railroad ROW) | | | | | <input type="checkbox"/> |
| Copy of (soil or land use) deed restriction (s) or deed notice if any required as a condition of closure | | | | | <input type="checkbox"/> |



commerce.wi.gov

ENVIRONMENTAL & REGULATORY SERVICES DIVISION
BUREAU OF PECFA
101 West Pleasant Street, Suite 100A
Milwaukee, Wisconsin 53212-3963
TDD #: (608) 264-8777
Fax #: (414) 220-5374
Jim Doyle, Governor
Mary P. Burke, Secretary

May 4, 2005

Mr. Peter Thompson
City of Watertown
106 Jones Street
P.O. Box 477
Watertown, WI 53094-0477

RE: **Final Closure**

Commerce # 53094-3719-18 **WDNR BRRS # 03-28-390478**
Third Street Parking Lot, 118 North 3rd Street, Watertown

Dear Mr. Thompson:

The Wisconsin Department of Commerce (Commerce) has received all items required as conditions for closure of the site referenced above. This case is now listed as "closed" on the Commerce database and will be included on the Wisconsin Department of Natural Resources (WDNR) Geographic Information System (GIS) Registry of Closed Remediation Sites to address residual soil and groundwater contamination. It is in your best interest to keep all documentation related to the environmental activities that were conducted.

If residual contamination is encountered in the future, it must be managed in accordance with all applicable state and federal regulations. If it is determined that any remaining contamination poses a threat, the case may be reopened and further investigation or remediation may be required.

Thank you for your efforts to bring this case to closure. If you have any questions, please contact me in writing at the letterhead address or by telephone at (414) 220-5376.

Sincerely,

A handwritten signature in black ink, appearing to read "L.M. Michalets", written over a horizontal line.

Linda M. Michalets
Hydrogeologist
Site Review Section

cc: Ms. Krista Krenz, Shaw Environmental, Inc.
Case File



ENVIRONMENTAL & REGULATORY SERVICES DIVISION
BUREAU OF PECFA
101 West Pleasant Street, Suite 100A
Milwaukee, Wisconsin 53212-3963
TDD #: (608) 264-8777
Fax #: (414) 220-5374
Jim Doyle, Governor
Mary P. Burke, Secretary

March 24, 2005

Mr. Peter Thompson
City of Watertown
106 Jones Street
P.O. Box 477
Watertown, WI 53094-0477

RE: **Conditional Case Closure**
Commerce # 53094-3719-18 WDNR BRRTS # 03-28-390478
Third Street Parking Lot, 118 North 3rd Street, Watertown

Dear Mr. Thompson:

The Wisconsin Department of Commerce (Commerce) has reviewed the request for case closure prepared by your consultant, Shaw Environmental, Inc., for the site referenced above. It is understood that residual soil and groundwater contamination remains on site. Commerce has determined that this site does not pose a significant threat to the environment and human health. No further investigation or remedial action is necessary.

The following condition must be satisfied to obtain final closure:

- The five monitoring wells must be properly abandoned and the appropriate documentation forwarded to me at the letterhead address.

This letter serves as your written notice of "no further action". Timely filing of your final PECFA claim (if applicable) is encouraged. If your claim is not received within 120 days of the date of this letter, interest costs incurred after 60 days of the date of this letter will not be eligible for PECFA reimbursement.

Thank you for your efforts to protect Wisconsin's environment. If you have any questions, please contact me in writing at the letterhead address or by telephone at (414) 220-5376.

Sincerely,

A handwritten signature in black ink, appearing to read "L. M. Michalets", with a long, sweeping horizontal stroke extending to the right.

Linda M. Michalets
Hydrogeologist
Site Review Section

cc: Mr. John Zajakowski, Shaw Environmental, Inc.
Case File

Map created Wed May 04 15:38:30 CDT 2005

Legend

- Closed Remediation Sites
- Groundwater
- ▲ Soil
- Groundwater and Soil
- Offsource Contamination
- County Boundary
- 24K Open Water
- Municipalities



Scale: 1:979

DO NOT USE FOR NAVIGATION

713059

591 PAGE 137

STATE BAR OF WISCONSIN - FORM 4
WARRANTY DEED
THIS SPACE RESERVED FOR RECORDING DATA

STATE OF WISCONSIN } ss.
Jefferson County }

Received for record this 28th day
of December A. D. 1973 at 8
o'clock 8 M. and recorded by Vol.
591 of Records, page 137

Patricia D. Seefeldt
Janet Schifano

BY THIS DEED, First State Savings and Loan Associ-
ation, a corporation duly organized and existing
under and by virtue of the laws of the State of
Wisconsin, located at Watertown, Wisconsin,
Grantor conveys and warrants to City of Watertown, a Municipal
corporation located at Watertown, Wisconsin,

Grantee
for a valuable consideration of Twenty-five Thousand Dollars
(\$25,000.00)

the following described real estate in Jefferson County, State of Wisconsin:

RETURN TO

Duesler & Bender S.C.
Chg. Bernice F. Burti-City Clerk

Tax Key # _____
This is NOT homesteaded property.

The North 52 feet of Lots One (1) and Two (2) in Block Six (6) of Cole,
Bailey & Co.'s Plat of the Village (now City) of Watertown, on the East side
of Rock River, excepting therefrom, however, the West 9 feet of said Lot
Two (2), but together with a right of way over said 9 feet.

2009 Parcel ID: 28-291-0815-0412-163

Exempt #2.

Exception to warranties: Recorded easements and restrictions, if any.

Executed at Watertown, Wisconsin, this 27th day of December, 1973.

SIGNED AND SEALED IN PRESENCE OF

FIRST STATE SAVINGS AND LOAN
ASSOCIATION

By Paul C. Kehrer, President

By Martin W. Uttech, Secretary

Signatures of Paul C. Kehrer, President, and Martin W. Uttech, Secretary, of
said First State Savings and Loan Association, a Wisconsin corporation,
authenticated this 27th day of December, 1973.

George E. Niemann
George E. Niemann
Title: Member State Bar of Wisconsin

STATE OF WISCONSIN } ss.
County }

Personally came before me, this _____ day of _____, 19____,
the above named _____

to me known to be the person who executed the foregoing instrument and acknowledged the same.

This instrument was drafted by _____

George E. Niemann
Attorney at Law.

Notary Public _____ County, Wis.

The use of witnesses is optional.

My Commission (Expires) (Is) _____

Names of persons signing in any capacity should be typed or printed below their signatures.






(USGS 1971)
WATERTOWN QUADRANGLE



LOCATION

SCALE
1:24000

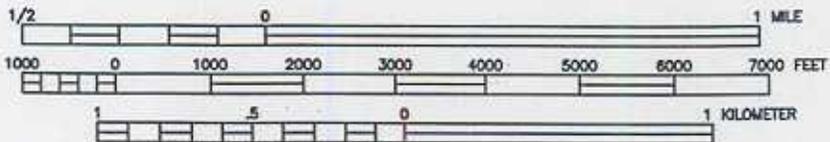

CONTOUR INTERVAL 10 FEET




| | | | | |
|---|---|-------------|-------------|--------------|
|  Shaw E&I, Inc. | 118 NORTH 3RD STREET PROPERTY WATERTOWN, WISCONSIN | | | |
| | FIGURE 1 SITE LOCATION MAP | | | |
| DESIGNED BY | VLL | 01/03/05 | CHECKED BY | |
| DRAWN BY | KFK | 01/03/05 | APPROVED BY | |
| SIZE | SCALE | DRAWING NO. | SHEET NO. | REVISION NO. |
| A | AS SHOWN | 100432.201 | 1 OF 1 | 0 |

| REV | DATE | BY | CHK'D | APPROV'D | DESCRIPTION/ISSUE |
|-----|------|----|-------|----------|-------------------|
| | | | | | |
| | | | | | |
| | | | | | |
| | | | | | |

LEGEND

- — — APPROXIMATE PROPERTY BOUNDARY
- - - - - FORMER UST BASIN
- Ⓜ SEWER MANHOLE
- Ⓢ UTILITY POLE

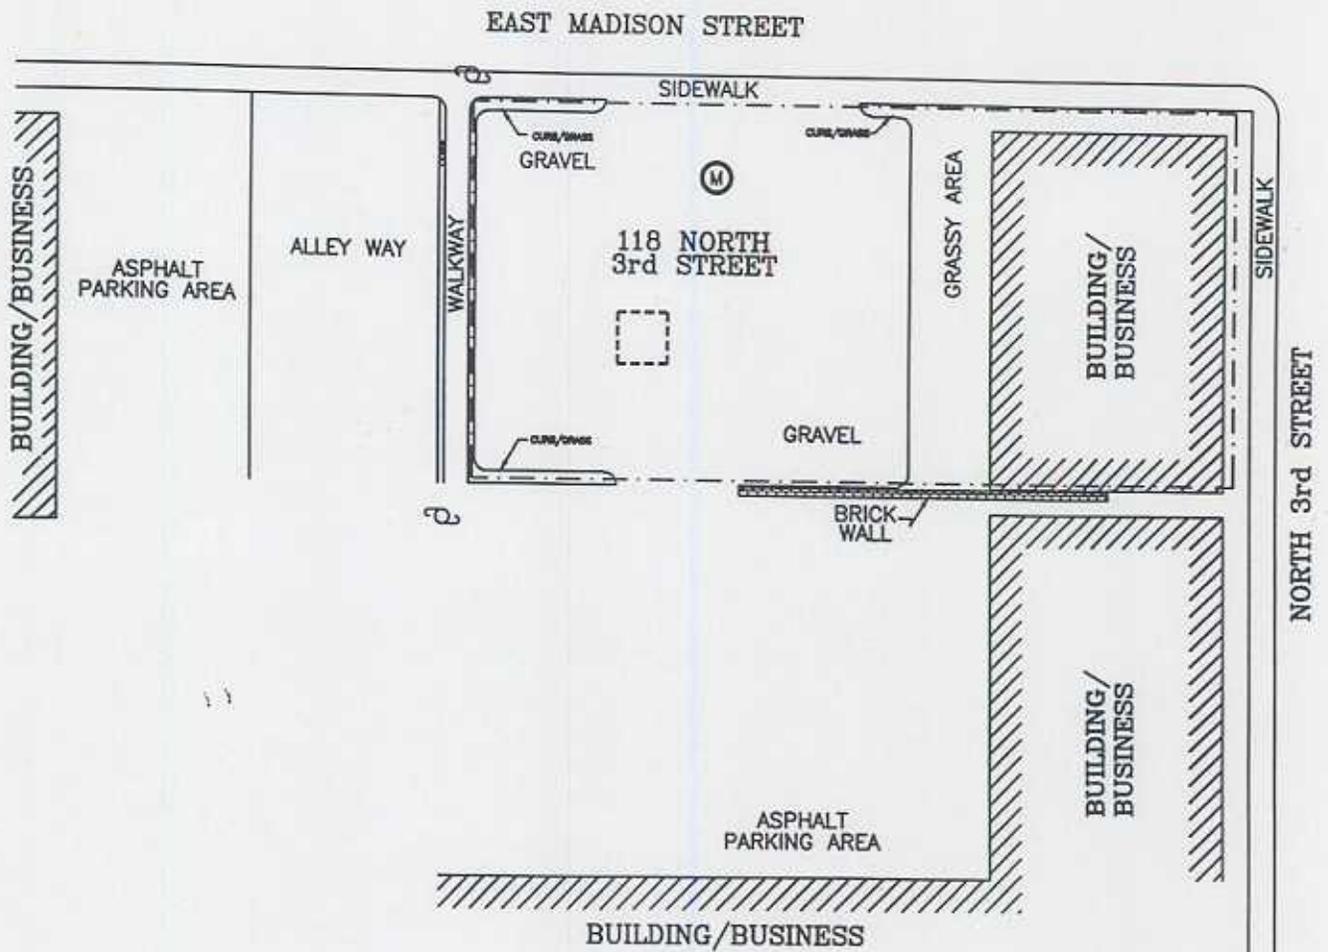

| | | | | | |
|-------------|--------|---|-------------|--------------|--|
| | | 118 NORTH 3RD STREET PROPERTY WATERTOWN, WISCONSIN | | | |
| | | FIGURE 2 SITE PLAN VIEW | | | |
| DESIGNED BY | VLL | 12/21/04 | CHECKED BY | | |
| DRAWN BY | NFK | 12/28/04 | APPROVED BY | | |
| SIZE: | SCALE: | DRAWING NO. | SHEET NO. | REVISION NO. | |
| A | 1"=30' | 100432.202 | 1 OF 1 | 0 | |

Table 2

**Groundwater Sample Laboratory Analytical Results
Third Street Parking Lot Site
Watertown, Wisconsin**

| Sample Location | Sample Date | Benzene | Ethylbenzene | Toluene | Xylenes | TMBs | MTBE | Isopropylbenzene | n-Propylbenzene | p-Isopropyltoluene | sec-Butylbenzene | Naphthalene | GRO |
|-----------------|-------------|-----------|--------------|---------|---------|--------------|-------|------------------|-----------------|--------------------|------------------|-------------|--------|
| TMW-1 | 10/24/03 | <6.0 | 230 | 15 | 557 | 1,870 | 27 | NA | NA | NA | NA | NA | 13,000 |
| TMW-10 | 2/17/04 | 1.3 | 1.1 | 3.3 | 3.4 | 1.53 | <0.36 | NA | NA | NA | NA | NA | <50 |
| TMW-11 | 2/17/04 | 0.25 | <0.40 | 0.55 | <1.10 | <0.79 | <0.36 | NA | NA | NA | NA | NA | <50 |
| TMW-13 | 2/17/04 | 0.24 | 0.59 | 0.56 | 1.29 | 0.89 | <0.36 | NA | NA | NA | NA | NA | 150 |
| MW-1 | 5/21/04 | <0.41 | <0.54 | <0.67 | <2.63 | <1.80 | <0.61 | <0.59 | <0.81 | <0.67 | <0.89 | <0.74 | <50 |
| | 9/23/04 | <0.14 | <0.40 | <0.36 | <1.10 | <0.79 | <0.36 | NA | NA | NA | NA | NA | NA |
| MW-2 | 5/21/04 | <0.41 | <0.54 | <0.67 | <2.63 | <1.80 | <0.61 | <0.59 | <0.81 | <0.67 | <0.89 | <0.74 | <50 |
| | 9/23/04 | <0.14 | <0.40 | <0.36 | <1.10 | <0.79 | <0.36 | NA | NA | NA | NA | NA | NA |
| MW-3 | 5/21/04 | <0.41 | <0.54 | <0.67 | <2.63 | <1.80 | <0.61 | <0.59 | <0.81 | <0.67 | <0.89 | <0.74 | <50 |
| | 9/23/04 | <0.14 | <0.40 | <0.36 | <1.10 | <0.79 | <0.36 | NA | NA | NA | NA | NA | NA |
| MW-4 | 5/21/04 | <0.41 | 7.6 | 1.3 | 5.1 | 77 | <0.61 | 7.0 | 12 | 3.1 | <0.89 | 7.8 | 980 |
| | 9/23/04 | 1.2 | 3.5 | 1.1 | 1.82 | 2.0 | 1.8 | NA | NA | NA | NA | NA | NA |
| MW-5 | 5/21/04 | 10 | <i>340</i> | 5.3 | 122 | <i>290</i> | <1.5 | 24 | 30 | 7.6 | 4.8 | 47 | 2,100 |
| | 9/23/04 | 17 | <i>350</i> | 6.6 | 53 | <i>114</i> | 0.88 | NA | NA | NA | NA | 46 | NA |
| NR 140 ES | | 5.0 | 700 | 1,000 | 10,000 | 480 | 60 | NS | NS | NS | NS | 40 | NS |
| NR 140 PAL | | 0.50 | 140 | 200 | 1,000 | 96 | 12 | NS | NS | NS | NS | 8 | NS |

Notes:

Results are reported in ppb

Bold indicates value equals or exceeds the NR 140 ES*Italics* indicates value equals or exceeds the NR 140 PAL

ES: Enforcement standard

PAL: Preventive action limit

TMB: Trimethylbenzene

MTBE: Methyl t-butyl ether

NS: No standard

GRO: Gasoline range organics

NA: Not analyzed

Checked by: _____

Approved by: _____

Table 1

**Site Investigation Soil Sample Laboratory Analytical Results
Third Street Parking Lot Site
Watertown, Wisconsin**

| Sample Location | Sample Depth (feet bls) | Date | Benzene | Ethylbenzene | Toluene | Xylenes | TMBs | MTBE | GRO (ppm) | Lead (ppm) |
|------------------------------|-------------------------|----------|---------|--------------|---------|---------------|--------|------|-----------|------------|
| GP-1 | 0-2' | 10/24/03 | <25 | <25 | <25 | <75 | <50 | <25 | 4.0 | 5.8 |
| | 10-11' | 10/24/03 | <200 | 2,400 | <200 | 6,840 | 29,000 | 490 | 600 | NA |
| GP-2 | 0-2' | 10/24/03 | <25 | <25 | <25 | <75 | <50 | <25 | <2.6 | 4.3 |
| | 10-11' | 10/24/03 | <200 | 5,300 | <200 | 17,900 | 22,300 | <200 | 520 | NA |
| GP-3 | 2-4' | 10/24/03 | <25 | <25 | <25 | <75 | <50 | <25 | <2.6 | 3.5 |
| | 10-11' | 10/24/03 | <25 | <25 | <25 | <75 | 88 | <25 | 2.9 | NA |
| GP-4 | 0-2' | 10/24/03 | <25 | <25 | 740 | <75 | 239 | <25 | 3.8 | 150 |
| | 10-11' | 10/24/03 | <25 | <25 | <25 | 32 | 119 | <25 | 13 | NA |
| GP-5 | 0-2' | 10/24/03 | <25 | <25 | <25 | <75 | <50 | <25 | <2.9 | 8.8 |
| | 10-11' | 10/24/03 | <25 | <25 | <25 | <75 | <50 | <25 | <2.9 | NA |
| GP-6 | 10-11' | 10/24/03 | <25 | <25 | <25 | <75 | <50 | <25 | <2.8 | NA |
| GP-7 | 10-11' | 10/24/03 | <25 | <25 | <25 | <75 | <50 | <25 | <2.9 | NA |
| GP-10 | 10-12' | 2/17/04 | <25 | <25 | <25 | <75 | <50 | <25 | <2.8 | 5.0 |
| GP-11 | 10-12' | 2/17/04 | <25 | <25 | <25 | <75 | <50 | <25 | <2.8 | 6.0 |
| GP-12 | 10-12' | 2/17/04 | <25 | <25 | <25 | <75 | 33 | <25 | <2.8 | 5.3 |
| GP-13 | 10-12' | 2/17/04 | <25 | <25 | <25 | <75 | <50 | <25 | <2.8 | 5.9 |
| | 13' | 2/17/04 | <25 | <25 | <25 | <75 | 1,070 | <25 | 42 | 5.1 |
| GP-14 | 8' | 2/17/04 | <25 | <25 | <25 | <75 | <50 | <25 | <2.9 | 3.0 |
| NR 720 Generic Soil Standard | | | 5.5 | 2,900 | 1,500 | 4,100 | NS | NS | 100 | 50 |

Notes:

Results in ppb unless otherwise noted

Bold indicates value equals or exceeds the NR 720 generic soil standard

TMB: Trimethylbenzene

MTBE: Methyl t-butyl ether

GRO: Gasoline range organics


NS: No standard

NA: Not analyzed

bls: Below land surface

Checked by: _____

Approved by: _____

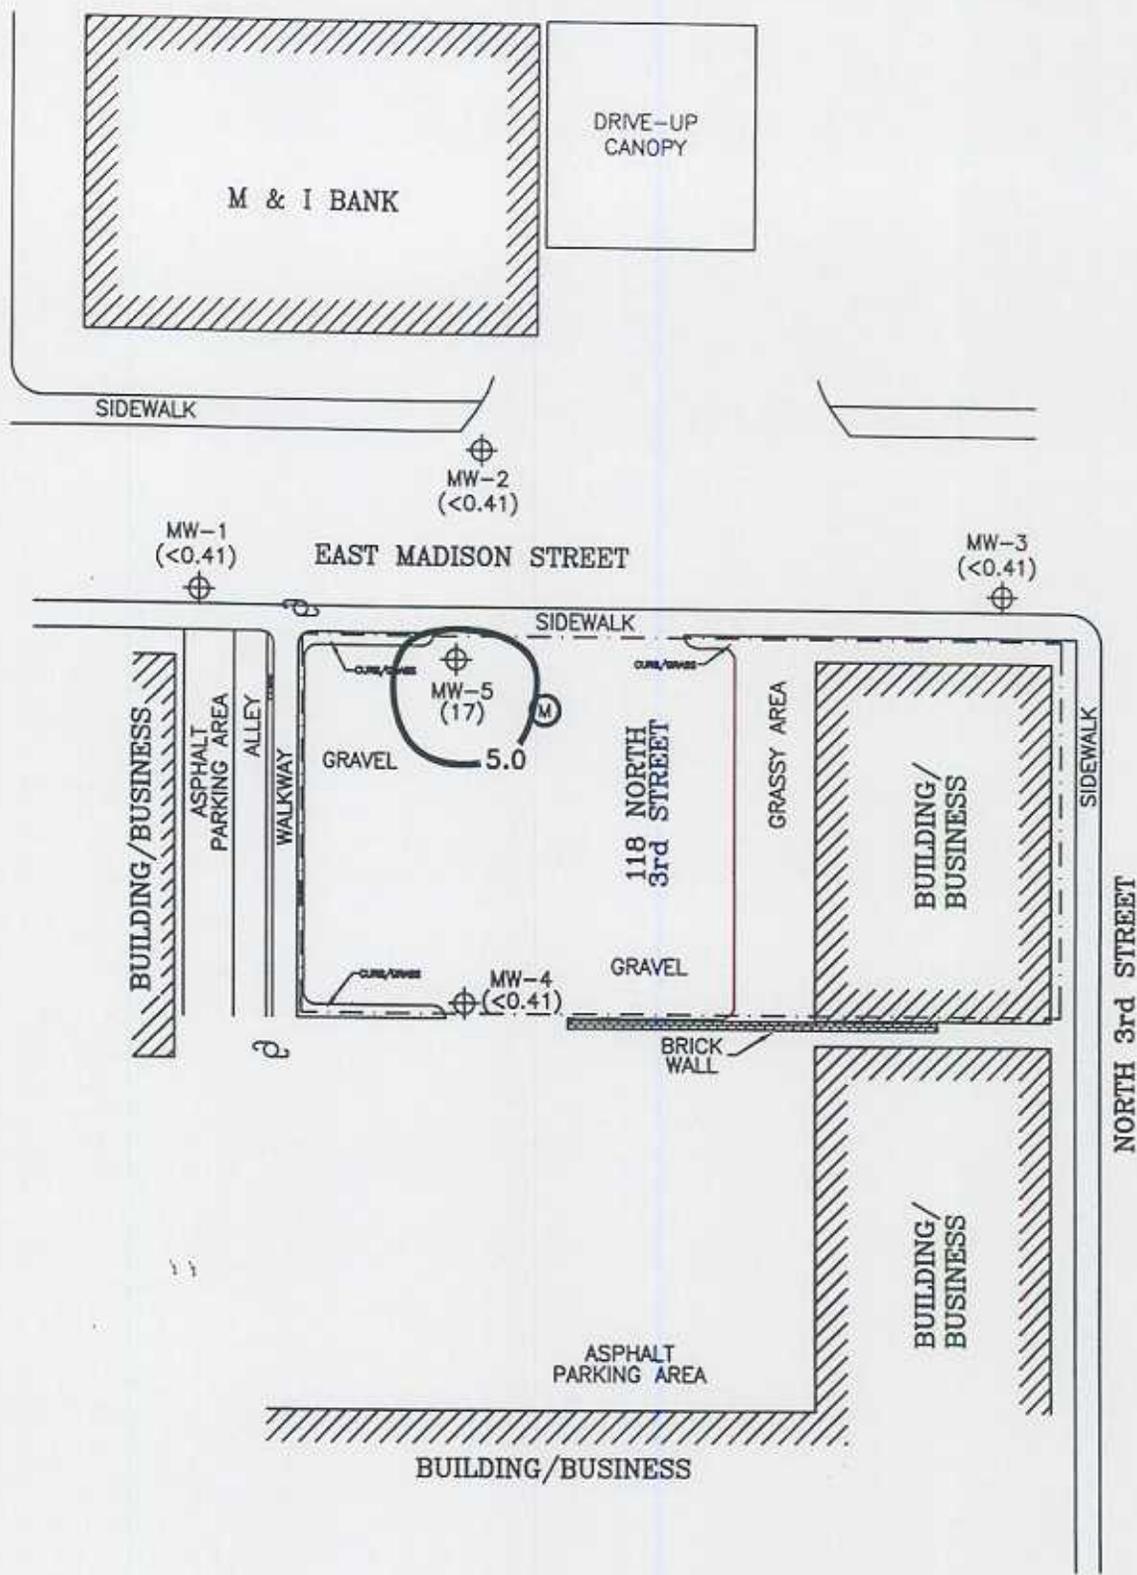

LEGEND

- APPROXIMATE PROPERTY BOUNDARY
- ⊙ (M) SEWER MANHOLE
- ⊙ (U) UTILITY POLE
- ⊕ MONITORING WELL
- () BENZENE CONCENTRATION IN ppb
- 5.0 ISOCONCENTRATION CONTOUR


| | | | | |
|-------------|--------|---|-------------|--------------|
| | | 118 NORTH 3RD STREET PROPERTY WATERTOWN, WISCONSIN | | |
| | | FIGURE 6 GROUNDWATER BENZENE DISTRIBUTION (09/23/04) | | |
| DESIGNED BY | VLL | 12/23/04 | CHECKED BY | |
| DRAWN BY | KFK | 12/23/04 | APPROVED BY | |
| SIZE: | SCALE: | DRAWING NO. | SHEET NO. | REVISION NO. |
| A | 1"=30' | 100432.206 | 1 OF 1 | 0 |

Table 3
Groundwater Elevation Data
Third Street Parking Lot Site
Watertown, Wisconsin

| Well Location | TOC Elevation | Date | Depth to Water | Groundwater Elevation |
|---------------|---------------|---------|----------------|-----------------------|
| MW-1 | 95.60 | 5/21/04 | 6.73 | 88.87 |
| | | 9/23/04 | 7.74 | 87.86 |
| MW-2 | 96.67 | 5/21/04 | 7.13 | 89.54 |
| | | 9/23/04 | 8.25 | 88.42 |
| MW-3 | 97.82 | 5/21/04 | 6.95 | 90.87 |
| | | 9/23/04 | 8.30 | 89.52 |
| MW-4 | 97.61 | 5/21/04 | 7.32 | 90.29 |
| | | 9/23/04 | 8.66 | 88.95 |
| MW-5 | 97.06 | 5/21/04 | 6.66 | 90.40 |
| | | 9/23/04 | 8.28 | 88.78 |

Notes:


All elevations are in feet referenced to a site datum of 100 feet
 TOC: Top of casing

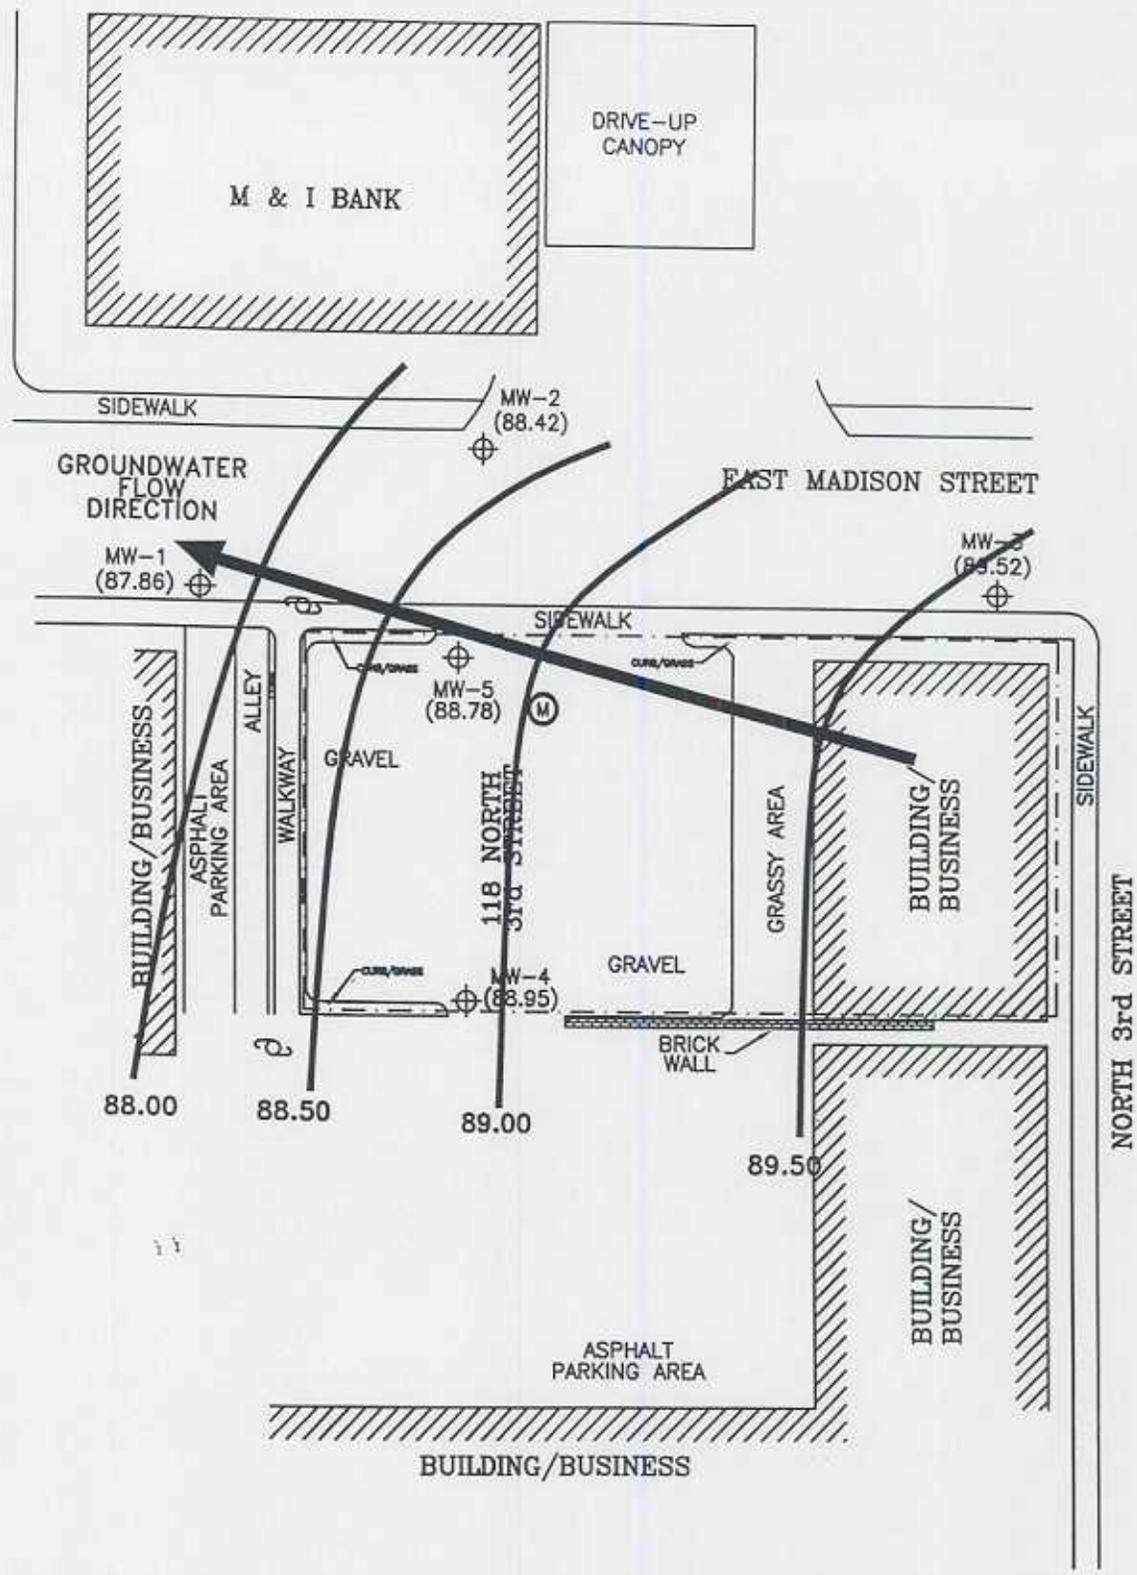

LEGEND

- APPROXIMATE PROPERTY BOUNDARY
- (M) SEWER MANHOLE
- ⊕ UTILITY POLE
- ⊕ MONITORING WELL
- () GROUNDWATER ELEVATION IN FEET ABOVE MSL
- 90.00 ISOELEVATION CONTOUR

| | | | | |
|--|---|-------------|-------------|--------------|
|  Shaw E&I, Inc. | 118 NORTH 3RD STREET PROPERTY WATERTOWN, WISCONSIN | | | |
| | FIGURE 7 POTENTIOMETRIC SURFACE (09/23/04) | | | |
| DESIGNED BY | VLL | 12/23/04 | CHECKED BY | |
| DRAWN BY | KFK | 12/29/04 | APPROVED BY | |
| SIZE: | SCALE: | DRAWING NO. | SHEET NO. | REVISION NO. |
| A | 1"=30' | 100-432.207 | 1 OF 1 | 0 |

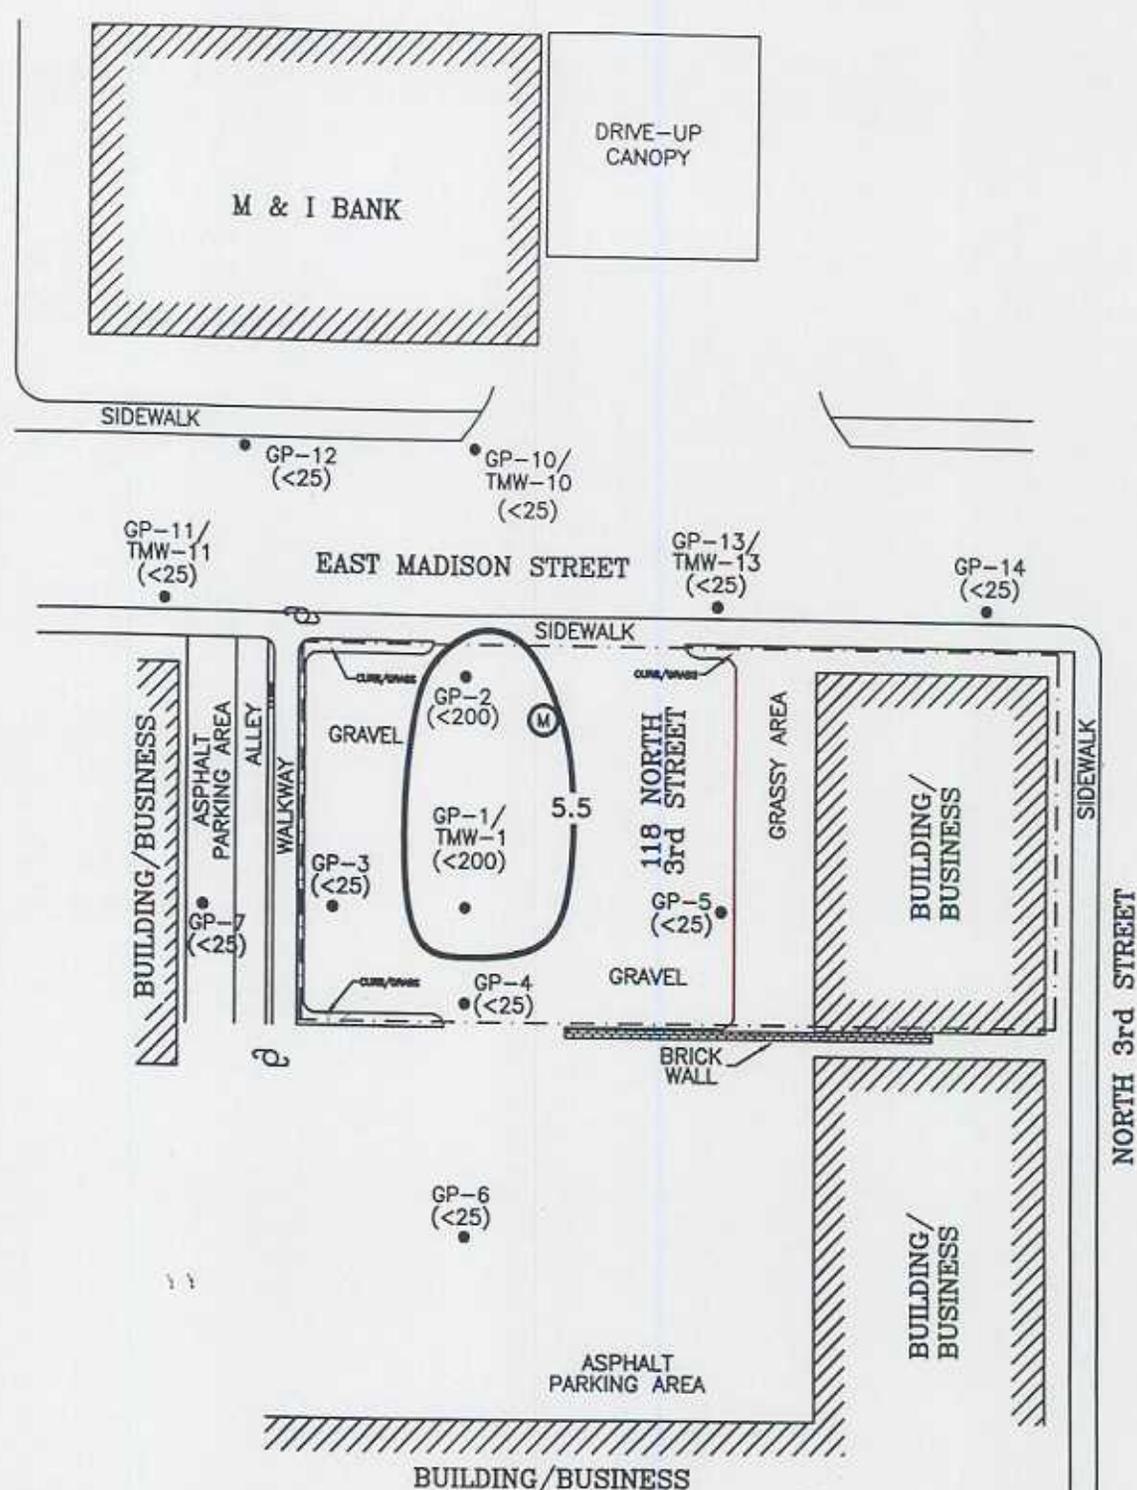


LEGEND

- APPROXIMATE PROPERTY BOUNDARY
- (M) SEWER MANHOLE
- UTILITY POLE
- GEOPROBE BORING/MONITORING WELL LOCATION
- () BENZENE CONCENTRATION IN ppb
- 5.5 ISOCONCENTRATION CONTOUR

NOTE:



GP-1 THROUGH GP-7 SAMPLES WERE COLLECTED ON 10/24/03
 GP-10 THROUGH GP-14 SAMPLES WERE COLLECTED ON 02/17/04

| | | | | |
|-------------|---|-------------|-------------|--------------|
| | 118 NORTH 3RD STREET PROPERTY WATERTOWN, WISCONSIN | | | |
| | FIGURE 3 SOIL BENZENE DISTRIBUTION (10/24/03 & 02/17/04) | | | |
| DESIGNED BY | VLL | 07/12/04 | CHECKED BY | |
| DRAWN BY | KFK | 07/22/04 | APPROVED BY | |
| SIZE: | SCALE: | DRAWING NO. | SHEET NO. | REVISION NO. |
| A | 1"=30' | 100432.203 | 1 OF 1 | 0 |

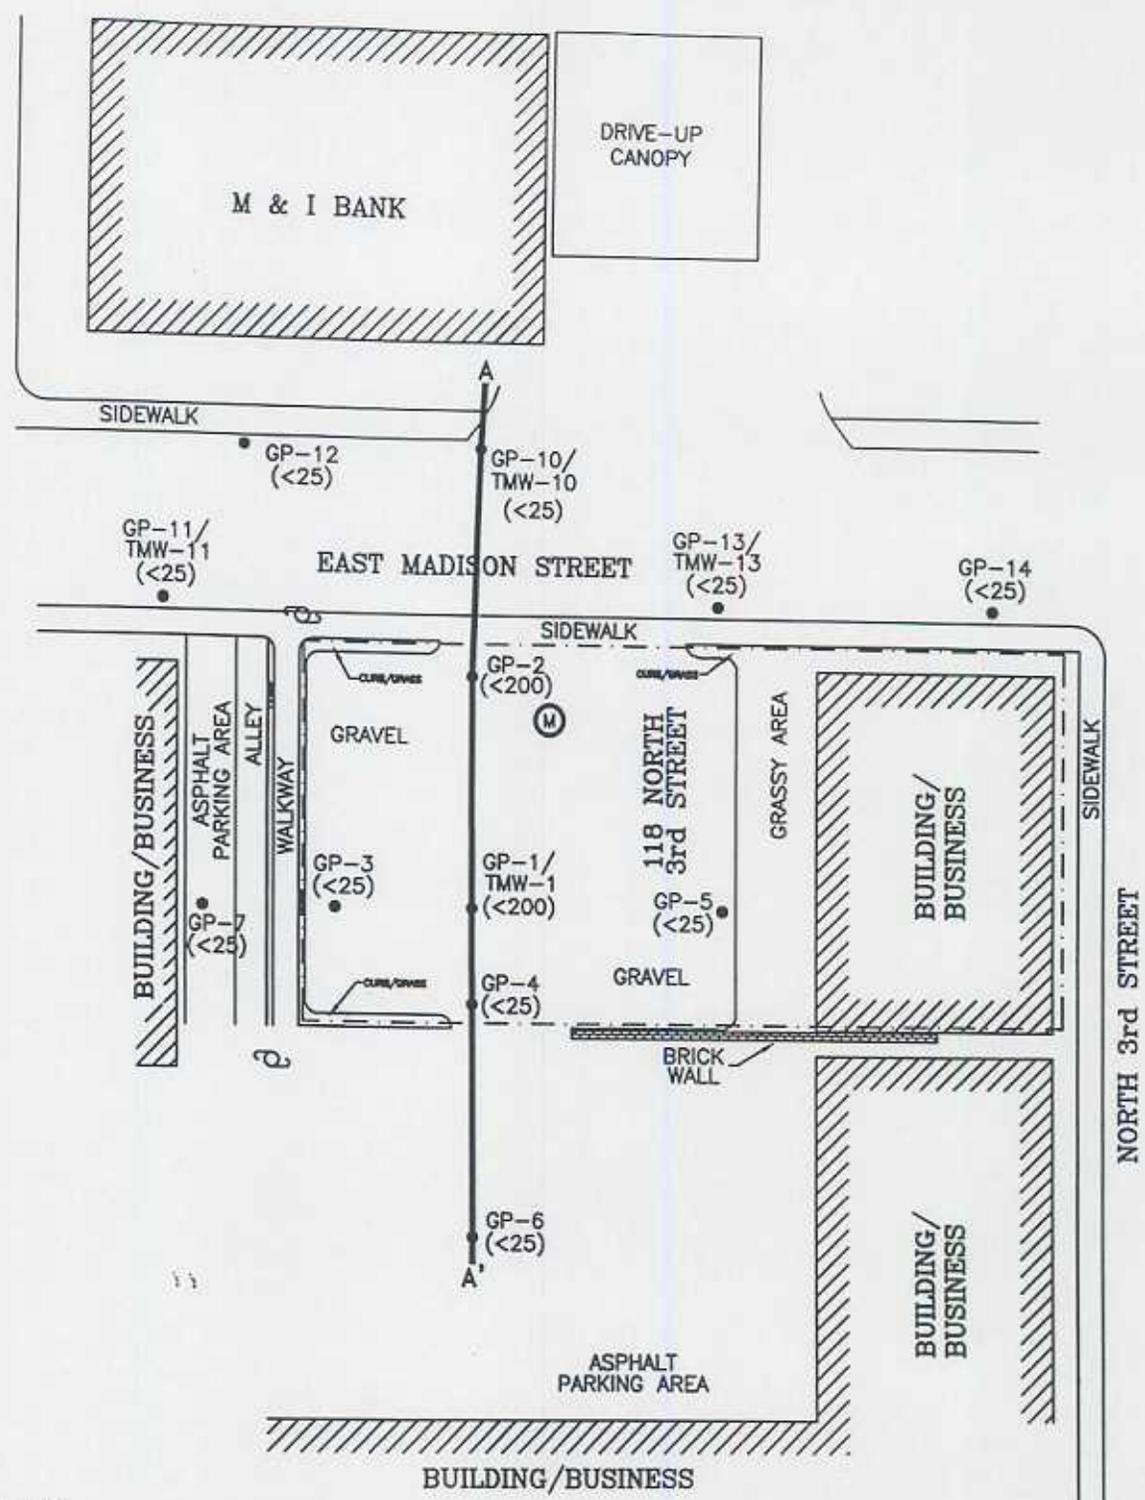


NOTE:
 GP-1 THROUGH GP-7 SAMPLES WERE COLLECTED ON 10/24/03
 GP-10 THROUGH GP-14 SAMPLES WERE COLLECTED ON 02/17/04

| | | | | | |
|-------------|--------|--|-------------|--------------|--|
| | | 118 NORTH 3RD STREET PROPERTY WATERTOWN, WISCONSIN | | | |
| | | FIGURE 4 GEOLOGIC CROSS-SECTION PLAN VIEW | | | |
| DESIGNED BY | VLL | 12/23/04 | CHECKED BY | | |
| DRAWN BY | KFK | 12/29/04 | APPROVED BY | | |
| SIZE: | SCALE: | DRAWING NO. | SHEET NO. | REVISION NO. | |
| A | 1"=30' | 100432.204 | 1 OF 1 | 0 | |

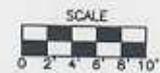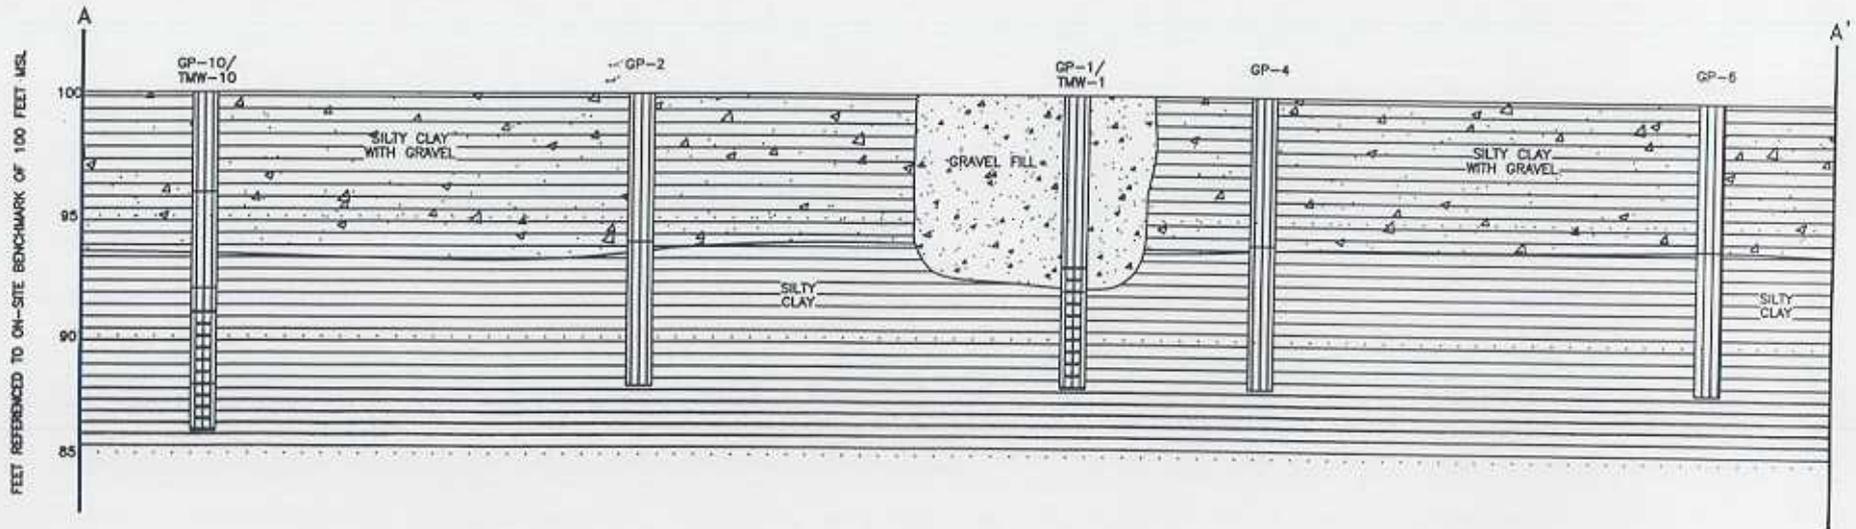

| | | | |
|---|------------------|---|---------------------------|
|  Shaw Shaw Environmental, Inc. | | 850 Highway 153, Suite F Mosinee, WI 54455 (715) 693-1750 | |
| | | REV. NO.: | DRAWING DATE: 01/03/05 |
| GEOLOGIC CROSS-SECTION A-A' | | | |
| SITE: 118 NORTH 3RD STREET PROPERTY | | PM: JCZ | |
| LOCATION: WATERTOWN, WISCONSIN | | PE/RG: | |
| DESIGNED: KFK | DETAILED: KFK | PROJECT NO.: 100432 | FIGURE: 5 |

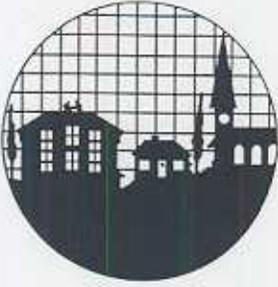

CITY OF WATERTOWN

ENGINEERING DEPARTMENT

106 Jones Street • P.O. Box 477 • Watertown, WI 53094-0477
(920) 262-4040 • FAX (920) 262-4042

JOSEPH M. RADOCA
City Engineer
(920) 262-4050

PETER L. THOMPSON
Assistant City Engineer
(920) 262-4045

December 27, 2004

Mr. Wendall Wojner
Wisconsin Department of Natural Resources
3911 Fish Hatchery Road
Fitchburg, WI 53711

Re: GIS Registry RP Legal Description Signed Statement for the Third Street Parking Lot Site, 118 N. 3rd Street, Watertown, Wisconsin
Shaw Project No.100432
PECFA ID No. 53094-3719-18
WDNR BRRTS No. 03-28-390478

Dear Mr. Wojner:

Please be advised that the legal description in the NW ¼, NE ¼, Section 4, Township 8 North, Range 15 East in the City of Watertown, Jefferson County, Wisconsin, has been attached for the Third Street Parking Lot Site, located at 118 N. Third Street, Watertown, Wisconsin, and is located within the contaminated site boundaries.

Sincerely,

Peter Thompson
Assistant City Engineer

PT/nmz

11