

GIS Registry Disclaimer

This case was closed by the DNR prior to August 1, 2002, when DNR began adding approved cleanups with residual soil contamination into the GIS Registry. Certain documents that are currently required by ch. NR 726, Wis. Adm. Code may therefore not be included in this packet as they were unavailable at the time the original case was closed.

The information contained in this document was assembled by DNR from a previously closed case file, and added to the GIS Registry to provide the public with information on closed sites with residual soil and/or groundwater contamination remaining above applicable state standards.

GIS REGISTRY

Cover Sheet

July, 2008
(RR 5367)

Source Property Information

BRRTS #:

ACTIVITY NAME:

PROPERTY ADDRESS:

MUNICIPALITY:

PARCEL ID #:

CLOSURE DATE:

FID #:

DATCP #:

COMM #:

*WTM COORDINATES:

X: Y:

** Coordinates are in
WTM83, NAD83 (1991)*

WTM COORDINATES REPRESENT:

- Approximate Center Of Contaminant Source
 Approximate Source Parcel Center

Please check as appropriate: (BRRTS Action Code)

Contaminated Media:

Groundwater Contamination > ES (236)

Contamination in ROW

Off-Source Contamination

*(note: for list of off-source properties
see "Impacted Off-Source Property")*

Soil Contamination > *RCL or **SSRCL (232)

Contamination in ROW

Off-Source Contamination

*(note: for list of off-source properties
see "Impacted Off-Source Property")*

Land Use Controls:

Soil: maintain industrial zoning (220)

*(note: soil contamination concentrations
between residential and industrial levels)*

Structural Impediment (224)

Site Specific Condition (228)

Cover or Barrier (222)

*(note: maintenance plan for
groundwater or direct contact)*

Vapor Mitigation (226)

Maintain Liability Exemption (230)

*(note: local government or economic
development corporation)*

Monitoring wells properly abandoned? (234)

Yes No N/A

** Residual Contaminant Level*

***Site Specific Residual Contaminant Level*

This Adobe Fillable form is intended to provide a list of information that is required for evaluation for case closure. It is to be used in conjunction with Form 4400-202, Case Closure Request. The closure of a case means that the Department has determined that no further response is required at that time based on the information that has been submitted to the Department.

NOTICE: Completion of this form is mandatory for applications for case closure pursuant to ch. 292, Wis. Stats. and ch. NR 726, Wis. Adm. Code, including cases closed under ch. NR 746 and ch. NR 726. The Department will not consider, or act upon your application, unless all applicable sections are completed on this form and the closure fee and any other applicable fees, required under ch. NR 749, Wis. Adm. Code, Table 1 are included. It is not the Department's intention to use any personally identifiable information from this form for any purpose other than reviewing closure requests and determining the need for additional response action. The Department may provide this information to requesters as required by Wisconsin's Open Records law [ss. 19.31 - 19.39, Wis. Stats.].

BRRTS #: PARCEL ID #:

ACTIVITY NAME: WTM COORDINATES: X: Y:

CLOSURE DOCUMENTS (the Department adds these items to the final GIS packet for posting on the Registry)

- Closure Letter**
- Maintenance Plan** (if activity is closed with a land use limitation or condition (land use control) under s. 292.12, Wis. Stats.)
- Conditional Closure Letter**
- Certificate of Completion (COC)** for VPLE sites

SOURCE LEGAL DOCUMENTS

- Deed:** The most recent deed as well as legal descriptions, for the **Source Property** (where the contamination originated). Deeds for other, off-source (off-site) properties are located in the **Notification** section.
Note: If a property has been purchased with a land contract and the purchaser has not yet received a deed, a copy of the land contract which includes the legal description shall be submitted instead of the most recent deed. If the property has been inherited, written documentation of the property transfer should be submitted along with the most recent deed.
- Certified Survey Map:** A copy of the certified survey map or the relevant section of the recorded plat map for those properties where the legal description in the most recent deed refers to a certified survey map or a recorded plat map. (lots on subdivided or platted property (e.g. lot 2 of xyz subdivision)).
Figure #: **Title:**
- Signed Statement:** A statement signed by the Responsible Party (RP), which states that he or she believes that the attached legal description accurately describes the correct contaminated property.

MAPS (meeting the visual aid requirements of s. NR 716.15(2)(h))

- Maps must be no larger than 8.5 x 14 inches unless the map is submitted electronically.
- Location Map:** A map outlining all properties within the contaminated site boundaries on a U.S.G.S. topographic map or plat map in sufficient detail to permit easy location of all parcels. If groundwater standards are exceeded, include the location of all potable wells within 1200 feet of the site.
Note: Due to security reasons municipal wells are not identified on GIS Packet maps. However, the locations of these municipal wells must be identified on Case Closure Request maps.
Figure #: 1 **Title: site location**
 - Detailed Site Map:** A map that shows all relevant features (buildings, roads, individual property boundaries, contaminant sources, utility lines, monitoring wells and potable wells) within the contaminated area. This map is to show the location of all contaminated public streets, and highway and railroad rights-of-way in relation to the source property and in relation to the boundaries of groundwater contamination exceeding a ch. NR 140 Enforcement Standard (ES), and/or in relation to the boundaries of soil contamination exceeding a Residual Contaminant Level (RCL) or a Site Specific Residual Contaminant Levels (SSRCL) as determined under s. NR 720.09, 720.11 and 720.19.
Figure #: 1 **Title: site map**
 - Soil Contamination Contour Map:** For sites closing with residual soil contamination, this map is to show the location of all contaminated soil and a single contour showing the horizontal extent of each area of contiguous residual soil contamination that exceeds a Residual Contaminant Level (RCL) or a Site Specific Residual Contaminant Level (SSRCL) as determined under s. NR 720.09, 720.11 and 720.19.
Figure #: 7 **Title: post-remedial soil sample location map**

BRRTS #: 02-22-001570

ACTIVITY NAME: Reuter Oil Co.

MAPS (continued)

- Geologic Cross-Section Map:** A map showing the source location and vertical extent of residual soil contamination exceeding a Residual Contaminant Level (RCL) or a Site Specific Residual Contaminant Level (SSRCL). If groundwater contamination exceeds a ch. NR 140 Enforcement Standard (ES) when closure is requested, show the source location and vertical extent, water table and piezometric elevations, and locations and elevations of geologic units, bedrock and confining units, if any.

Figure #: **Title:**

Figure #: **Title:**

- Groundwater Isoconcentration Map:** For sites closing with residual groundwater contamination, this map shows the horizontal extent of all groundwater contamination exceeding a ch. NR140 Preventive Action Limit (PAL) and an Enforcement Standard (ES). Indicate the direction and date of groundwater flow, based on the most recent sampling data.

Note: *This is intended to show the total area of contaminated groundwater.*

Figure #: **Title:**

- Groundwater Flow Direction Map:** A map that represents groundwater movement at the site. If the flow direction varies by more than 20° over the history of the site, submit 2 groundwater flow maps showing the maximum variation in flow direction.

Figure #: 4 **Title: Water table map for December 14, 2000**

Figure #: **Title:**

TABLES (meeting the requirements of s. NR 716.15(2)(h)(3))

Tables must be no larger than 8.5 x 14 inches unless the table is submitted electronically. Tables must not contain shading and/or cross-hatching. The use of **BOLD** or *ITALICS* is acceptable.

- Soil Analytical Table:** A table showing remaining soil contamination with analytical results and collection dates.
Note: This is one table of results for the contaminants of concern. Contaminants of concern are those that were found during the site investigation, that remain after remediation. It may be necessary to create a new table to meet this requirement.

Table #: 2 **Title: Post - remedial soil analytical results summary**

- Groundwater Analytical Table:** Table(s) that show the most recent analytical results and collection dates, for all monitoring wells and any potable wells for which samples have been collected.

Table #: 3 **Title: Groundwater analytical results summary**

- Water Level Elevations:** Table(s) that show the previous four (at minimum) water level elevation measurements/dates from all monitoring wells. If present, free product is to be noted on the table.

Table #: **Title:**

IMPROPERLY ABANDONED MONITORING WELLS

For each monitoring well not properly abandoned according to requirements of s. NR 141.25 include the following documents.

Note: *If the site is being listed on the GIS Registry for only an improperly abandoned monitoring well you will only need to submit the documents in this section for the GIS Registry Packet.*

- Not Applicable**

- Site Location Map:** A map showing all surveyed monitoring wells with specific identification of the monitoring wells which have not been properly abandoned.

Note: *If the applicable monitoring wells are distinctly identified on the Detailed Site Map this Site Location Map is not needed.*

Figure #: **Title:**

- Well Construction Report:** Form 4440-113A for the applicable monitoring wells.

- Deed:** The most recent deed as well as legal descriptions for each property where a monitoring well was not properly abandoned.

- Notification Letter:** Copy of the notification letter to the affected property owner(s).

BRRTS #: 02-22-001570

ACTIVITY NAME: Reuter Oil Co.

NOTIFICATIONS

Source Property

- Letter To Current Source Property Owner:** If the source property is owned by someone other than the person who is applying for case closure, include a copy of the letter notifying the current owner of the source property that case closure has been requested.
- Return Receipt/Signature Confirmation:** Written proof of date on which confirmation was received for notifying current source property owner.

Off-Source Property

Group the following information per individual property and label each group according to alphabetic listing on the "Impacted Off-Source Property" attachment.

- Letter To "Off-Source" Property Owners:** Copies of all letters sent by the Responsible Party (RP) to owners of properties with groundwater exceeding an Enforcement Standard (ES), and to owners of properties that will be affected by a land use control under s. 292.12, Wis. Stats.
Note: Letters sent to off-source properties regarding residual contamination must contain standard provisions in Appendix A of ch. NR 726.

Number of "Off-Source" Letters:

- Return Receipt/Signature Confirmation:** Written proof of date on which confirmation was received for notifying any off-source property owner.
- Deed of "Off-Source" Property:** The most recent deed(s) as well as legal descriptions, for all affected deeded **off-source property(ies)**. This does not apply to right-of-ways.
Note: If a property has been purchased with a land contract and the purchaser has not yet received a deed, a copy of the land contract which includes the legal description shall be submitted instead of the most recent deed. If the property has been inherited, written documentation of the property transfer should be submitted along with the most recent deed.
- Letter To "Governmental Unit/Right-Of-Way" Owners:** Copies of all letters sent by the Responsible Party (RP) to a city, village, municipality, state agency or any other entity responsible for maintenance of a public street, highway, or railroad right-of-way, within or partially within the contaminated area, for contamination exceeding a groundwater Enforcement Standard (ES) and/or soil exceeding a Residual Contaminant Level (RCL) or a Site Specific Residual Contaminant Level (SSRCL).

Number of "Governmental Unit/Right-Of-Way Owner" Letters: 1



State of Wisconsin \ DEPARTMENT OF NATURAL RESOURCES

Scott McCallum, Governor
Darrell Bazzell, Secretary
Ruthe E. Badger, Regional Director

1500 N. Johns Street
Dodgeville, Wisconsin 53533
Telephone 608-935-3368
FAX 608-935-9652

November 2, 2001

Mr. Myron Reuter
Reuter Oil Co., Inc.
110 East Pine St.
Lancaster, WI 53813

File Ref: 02-22-001570

DEPT. OF NATURAL RESOURCES
SD HEADQUARTERS

Subject: Final Case Closure by Closure Committee, with Conditions Met
Reuter Oil Company, Ash and Jefferson Streets, Lancaster

Dear Mr. Reuter:

On May 21, 2001, the South Central Region Closure Committee as described above reviewed your site for closure. This committee reviews environmental remediation cases for compliance with state laws and standards to maintain consistency in the closure of these cases. On May 24, 2001, you were notified that the Closure Committee had denied closure, as there were several items that needed to be completed before closure could be granted.

On the following dates, the Department received correspondence indicating that you have complied with the conditions of closure.

July 25, 2001 – our Dodgeville office received a copy of the published public notice for performance standard closure.

August 27, 2001 – the Department received copies of the monitoring well abandonment forms.

August 28, 2001 – the Department received a copy of the letter sent to Mr. Jerry Carroll, Lancaster Department of Public Works, notifying his department of residual soil contamination in the right-of-way along Ash Street.


October 17, 2001 – the Department received “proof of filing” for the groundwater use restriction that was required as part of the closure activities.

Based on the correspondence and data provided, it appears that your site has been remediated to Department standards in accordance with s. NR 726.05, Wis. Adm. Code. The Department considers this case closed and no further investigation, remediation or other action is required at this time.

Please be aware that this case may be reopened pursuant to s. NR 726.09, Wis. Adm. Code, if additional information regarding site conditions indicates that contamination on or from the site poses a threat to public health, safety or welfare, or the environment.

The Department appreciates your efforts to restore the environment at this site. If you have any questions regarding this letter, please contact me at the number below.

Respectfully,

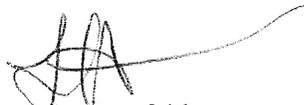A handwritten signature in black ink, appearing to read 'LH', with a long horizontal line extending to the right.

Linda Hanefeld
Hydrogeologist - Dodgeville Service Center
(608) 935-1948

cc: Rob Langdon, BT2, 2830 Dairy Drive, Madison, WI 53718-6751



file

State of Wisconsin \ DEPARTMENT OF NATURAL RESOURCES

Scott McCallum, Governor
Darrell Bazzell, Secretary
Ruthe E. Badger, Regional Director

1500 N. Johns Street
Dodgeville, Wisconsin 53533
Telephone 608-935-3368
FAX 608-935-9652

80

May 24, 2001

Mr. Myron Reuter
Reuter Oil Co., Inc.
110 East Pine St.
Lancaster, WI 53813

File Ref: 02-22-001570

Subject: Closure Request: Reuter Oil Co. – AST Spill Site, Ash and Jefferson Streets, Lancaster

Dear Mr. Reuter:

On May 21, 2001, your site was reviewed for closure by the South Central Region Closure Committee. This committee reviews environmental remediation cases for compliance with state statutes and rules to maintain consistency in the closure of these cases. After careful review of your closure request, the closure committee has decided that additional site work is necessary at the above-referenced site in order to meet the requirements for site closure.

The Committee has determined that your site can be granted closure provided the area of known soil contamination in the vicinity of SW10 remains under an impervious surface. Use of an impervious surface to address residual soil contamination is considered a “performance standard” by this Department (see s. NR720.19(2), Wis. Adm. Code). A properly installed and maintained impervious surface serves as an acceptable engineering control so that the residual contaminants left in the soil do not pose a threat to public health, safety, and welfare or the environment. Additionally, a deed restriction will be placed on your property as a notice to potential purchasers that the “performance standard” (the impervious surface) will need to be maintained.

In order to qualify for closure, the Committee is requiring that you:

- Publish a “public notice of remedial action” as defined in s. NR 714.07 (5), Wisconsin Administrative Code, *and* provide the Department with documentation of publication. The Department has not required that a remedial action option plan be submitted and, therefore, the public notice need not discuss review of the plan. Your consultant should serve as a point of contact for those parties interested in reviewing the site file, or for discussing the details of the use of an impervious surface as a performance standard.
- To meet the “class 1 notice” requirement, the Committee recommends that you publish the notice for a single day in the Grant County Herald Independent.
- Provide photos or other documentation demonstrating that the performance standard has been installed and is currently in good condition and free of cracks.
- Send the Department a copy of the property deed so that a deed restriction can be prepared. The Department will draft the deed restriction for this property.

Given current site conditions, additional requirements will need to be met prior to receiving “final” closure. These additional requirements will include:

1. Filing an on-site groundwater use restriction. The language for this restriction will be included in the performance standard deed restriction the Department will draft.
2. Properly abandoning the groundwater monitoring wells. The monitoring wells associated with the site must be properly abandoned in compliance with ch. NR 141, Wis. Adm. Code. Documentation of well abandonment must be submitted to me, at the address above, on forms provided by the Department of Natural Resources.
3. Notifying the municipal or state agency that maintains Ash Street of the residual soil contamination at soil boring location B2.

If there is residual groundwater or soil contamination in a public street or highway right-of-way, you must contact the municipality or state agency that maintains the street or highway to make sure that they are aware of the residual contamination, and negotiate an agreement with the municipality or state agency regarding the proper handling and disposal of any contaminated groundwater that may be extracted, and any contaminated soil that may be excavated, if the street or highway is reconstructed in the future. I would suggest that this notification be made in writing and sent "certified mail/return receipt requested" to ensure that the municipality or state agency has received the appropriate notice as required under s. NR726.05(2)(b)4., Wis. Adm. Code. Please note the notification address for state or federal highways is provided in that section, as well.

Please provide me with copies of your "proof of notification" for any residual soil and/or groundwater contamination along Ash Street. Proof of notification would include a copy of the written notification and a copy of the signed, returned receipt.

Based upon information obtained during site investigation and remediation, soil contamination above the residual contaminant levels outlined in s.NR720.09, Wis. Adm. Code, remains at this site. If site conditions change in the future and this residual contaminated soil is excavated, the property owner at that time will need to sample and analyze the excavated soil in order to determine whether the contamination still remains. Depending upon the results of that characterization, the owner may also have to properly store, treat, or dispose of any excavated materials, and/or take special precautions during excavation activities to prevent a direct contact threat to humans.

If you have any questions regarding this letter, the site closure process, or if you would like a copy of example deed restriction language that may be used, please contact me at the number shown below.

Sincerely,



Linda Hanefeld
Hydrogeologist – Dodgeville Service Center
Remediation and Redevelopment Program
(608) 935-1948

cc: Betty Socha, BT2, 2830 Dairy Drive, Madison, WI 53718-6751
Eric Scott, DCOM (label)

632554

DEED RESTRICTION

Document Number

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GRANT COUNTY, WI
RECEIVED FOR RECORD


Declaration of Restrictions

SEP 28 2001

In Re: Property described in attached Exhibit A, hereby made a part of this restriction.

at 10:15A M. and recorded in
Vol 890 of Records Page 28
Marilyn Pierce Register

STATE OF WISCONSIN

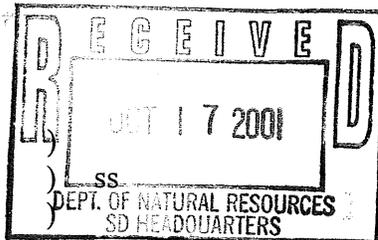

Recording Area

COUNTY OF GRANT

Name and Return Address

Myron Reuter 2300A
110 E. Pine St.
Lancaster WI 53813

WHEREAS, Myron C. Reuter is the owner of the above-described property.

Parcel Identification Number (PIN)

WHEREAS, one or more petroleum related discharges have occurred on this property. Petroleum-contaminated soil above the concentrations set forth in s. NR746.06(2), Table 1, Wis. Adm. Code, remains on this property at the following locations: during a September 30, 1998 sampling event, in the vicinity of soil sample SW9, at a depth of 5 feet below ground surface, ethylbenzene was detected at a concentration of 6090 parts per billion (ppb). During a September 30, 1998 sampling event, in the vicinity of SW10 at a depth of 5 feet below ground surface, benzene was detected at a concentration of 31,200 ppb; ethylbenzene was detected at a concentration of 78,600 ppb; toluene was detected at a concentration of 178,000 ppb; xylenes were detected at a concentration of 238,000 ppb; 1,2,4-trimethylbenzene was detected at a concentration of 91,000 ppb; and 1,3,5-trimethylbenzene was detected at a concentration of 23,700 ppb. For the approximate locations of these soil-sampling locations, see the attached Exhibit B, (BT2 Figure 7, dated 4/3/01), which is hereby made a part of this restriction.

Groundwater contamination above ch. NR 140, Wis. Adm. Code, enforcement standards existed on this property at the following location(s) on the following date(s) for the compounds listed:

632554

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WHEREAS, it is the desire and intention of the property owner to impose on the property restrictions which will make it unnecessary to conduct further soil and/or groundwater remediation activities on the property at the present time.

WHEREAS, natural attenuation has been approved by the Department of Natural Resources to remediate groundwater contamination exceeding ch. NR 140, Wis. Adm. Code, groundwater standards within the boundaries of this property.

WHEREAS, construction of wells where the water quality does not comply with drinking water standards in ch. NR 809, Wis. Adm. Code, is restricted by chs. NR 811 and

WHEREAS, it is the desire and intention of the property owner to impose on the property restrictions which will make it unnecessary to conduct further soil and/or groundwater remediation activities on the property at the present time.

WHEREAS, natural attenuation has been approved by the Department of Natural Resources to remediate groundwater contamination exceeding ch. NR 140, Wis. Adm. Code, groundwater standards within the boundaries of this property.

WHEREAS, construction of wells where the water quality does not comply with drinking water standards in ch. NR 809, Wis. Adm. Code, is restricted by chs. NR 811 and NR 812, Wis. Adm. Code. Special well construction standards or water treatment requirements, or both, or well construction prohibitions may apply.

NOW THEREFORE, the owner hereby declares that all of the property described above is held and shall be held, conveyed or encumbered, leased, rented, used, occupied and improved subject to the following limitation and restrictions:

The following activities are prohibited on that portion of the property described above where a cap, cover, or concrete pad has been placed, see attached Exhibit C, (BT2 Figure 7, dated January 11, 2001 [revised August 21, 2001]), which is hereby made a part of this restriction, unless prior written approval has been obtained from the Wisconsin Department of Natural Resources or its successor or assign: (1) Excavating or grading of the land surface; (2) Filling on the capped area; (3) Plowing for agricultural cultivation; and (4) Construction or installation of a building or other structure with a foundation that would sit on or be placed within the cap or cover. In addition, the impervious nature of the cap or cover must be maintained by the responsible party and/or property owner. The cap or cover shall be inspected at least annually, in Spring, for cracks, gaps or deterioration of the impervious surface. If, as a result of the inspection, maintenance of the cap or cover is warranted, then maintenance shall be performed. Records of these inspections, and any maintenance performed on the cap or cover shall be maintained by the responsible party or property owner, and should be transferred to any subsequent future responsible parties or property owners.

Anyone who proposes to construct or reconstruct a well on this property is required to contact the Department of Natural Resources' Bureau of Drinking Water and Groundwater, or its successor agency, to determine what specific requirements are applicable, prior to constructing or reconstructing a well on this property. No well may be constructed on this property unless applicable requirements are met.

If construction is proposed on this property that will require dewatering, or if groundwater is to be otherwise extracted from this property, while this groundwater use restriction is in effect, the groundwater shall be sampled and analyzed for contaminants that were previously detected on the property and any

extracted groundwater shall be managed in compliance with applicable statutes and rules.


This restriction is hereby declared to be a covenant running with the land and shall be fully binding upon all persons acquiring the above-described property whether by descent, devise, purchase or otherwise. This restriction insures to the benefit of and is enforceable by the Wisconsin Department of Natural Resources, its successors or assigns. The Department, its successors or assigns, may initiate proceedings at law or in equity against any person or persons who violate or are proposing to violate this covenant, to prevent the proposed violation or to recover damages for such violation.

Any person who is or becomes owner of the property described above may request that the Wisconsin Department of Natural Resources or its successor issue a determination that one or more of the restrictions set forth in this covenant is no longer required. Upon the receipt of such a request, the Wisconsin Department of Natural Resources shall determine whether or not the restrictions contained herein can be extinguished. If the Department determines that the restrictions can be extinguished, an affidavit, attached to a copy of the Department's written determination, may be recorded by the property owner or other interested party to give notice that this deed restriction, or portions of this deed restriction, are no longer binding.

IN WITNESS WHEREOF, the owner of the property has executed this Declaration of Restrictions, this 28th day of SEPT., 2001.

Signature

Printed Name:

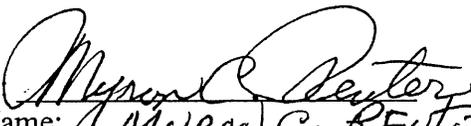
MYRON C. REUTER

Subscribed and sworn to before me
this 28th day of SEPT, 2001.


Notary Public, State of WISCONSIN
My commission 1/2/03

This document was drafted by the Department of Natural Resources using information provided by BT2, Inc., and Mr. Myron Reuter.

632554

Exhibit A, page 1

To be used in Illinois, Indiana, Iowa, Kansas, Michigan, Minnesota, Wisconsin and Wyoming.

B.P.#6980
Lancaster, W.I.

453885

This Indenture Witnesseth: That the grantor, AMOCO OIL COMPANY, a corporation organized and existing under and by virtue of the laws of the State of Maryland, for and in consideration of the sum of TEN and 00/100THS DOLLARS (\$.10.00), to it in hand paid, conveys and warrants to MYRON C. REUTER

GRANT and State of WISCONSIN, the following described real estate, situated in the County of GRANT and State of WISCONSIN to-wit:

That part of the West Half (W 1/2) of the Northeast Quarter (NE 1/4) of Section Three (3), Township Four (4) North, Range Three (3) West of the Fourth Principal Meridian (4th P.M.), described as:
Commencing at the Northeast corner of the Northwest Quarter (NW 1/4) of the Northeast Quarter (NE 1/4) of said Section Three (3); thence South Zero degrees, Sixteen minutes West (S 0° 16' W), Five Hundred Ninety and seven-tenths feet (590.7'); thence North Eighty-seven degrees, Fifty minutes West (N 87° 50' W), Three Hundred Ninety-two and four hundredths feet (392.04'), to the point of beginning (which point of beginning is the intersection of the South line of Ash Street with the Westerly line of the right of way of the Chicago and Northwestern Railroad Company); thence from said point of beginning, North Eighty-seven degrees, Fifty minutes West (N 87° 50' W), along the South line of Ash Street, in Lancaster, One Hundred Eighty and two-tenths feet (180.2'); thence due South One Hundred feet (100'); thence South Eighty-seven degrees, Fifty minutes East (S 87° 50' E), One Hundred Twenty-three and four-tenths feet (123.4'), to the Westerly line of the right of way of the Chicago and Northwestern Railroad Company; thence North Thirty degrees, Sixteen minutes East (N 30° 16' E) along said right of way, One Hundred Thirteen and four-tenths feet (113.4'), to the point of beginning; Said land designated as Lot 2A, Block 103 on the Assessment Plat of the City of Lancaster.

State Transfer

Tax Paid

\$ 4.50

Subject to taxes and special assessments, if any, against the said premises; also subject to zoning laws and municipal regulations, if any; building line restrictions and building restrictions of record, if any; and to any party wall agreements of record.

The grantee herein hereby covenants and agrees for himself, heirs, executors, administrators, grantees, successors and assigns, that no part of the real estate herein conveyed shall be used by said grantee, heirs, executors, administrators, grantees, successors or assigns, for the purpose of conducting or carrying on the business of selling, handling or dealing in gasoline, kerosene, benzol, naphtha, greases, lubricating oils, or any fuel to be used for internal combustion engines, or lubricants in any form. This covenant shall run with the land and be binding on said grantee, heirs, executors, administrators, grantees, successors and assigns, and inure to the benefit of the grantor herein, its successors and assigns.

The foregoing restrictions shall not apply to the sale, handling or dealing in petroleum products furnished by the grantor herein and in any event shall terminate and be of no further force and effect _____ years from the date hereof.

In Witness Whereof, the said grantor has caused this instrument to be signed by its Regional Real Estate Manager, and its corporate seal to be hereto affixed and attested by its Assistant Secretary, all this 17th day of May, 1976.

Signed, Sealed and Delivered in the presence of:

[Signature]

AMOCO OIL COMPANY

By *[Signature]*
Thomas J. Bugler, Regional Real Estate Manager

This Instrument was Prepared By:

J. D. Alexander, Attorney
200 East Randolph Dr.
Mail Code 6100
Chicago, Illinois 60601

Attest:
[Signature]
L. R. Borst, Assistant Secretary.

The following acknowledgment should be used for Illinois, Indiana, Kansas and Wisconsin.

STATE OF ILLINOIS, }
COUNTY OF COOK, } ss.

I, Faye Borth a Notary Public in and for said County and State, do hereby certify that Thomas J. Buehler and L. R. Borst, personally known to me to be the same persons whose names are subscribed to the foregoing instrument as Regional Real Estate Mgr. and Assistant Secretary of AMOCO OIL COMPANY, a Maryland corporation, appeared before me this day in person and acknowledged that they signed, sealed with the corporate seal of said corporation, and delivered the said instrument as their own free and voluntary act, and as the free and voluntary act of said corporation, for the uses and purposes therein set forth, and that they were duly authorized to execute the said instrument by the Board of Directors of said corporation.

Given under my hand and seal, this 17th day of May, 1976.

My commission expires March 23, 1979.

Faye Borth



GRANT COUNTY, WIS.
RECEIVED FOR RECORD


JUL 19 1976

at 9:15 A. M. and recorded in

Vol. 517 of Bonds Page 343

Marian L. Bauer Register

Done At Bk #30 P4.

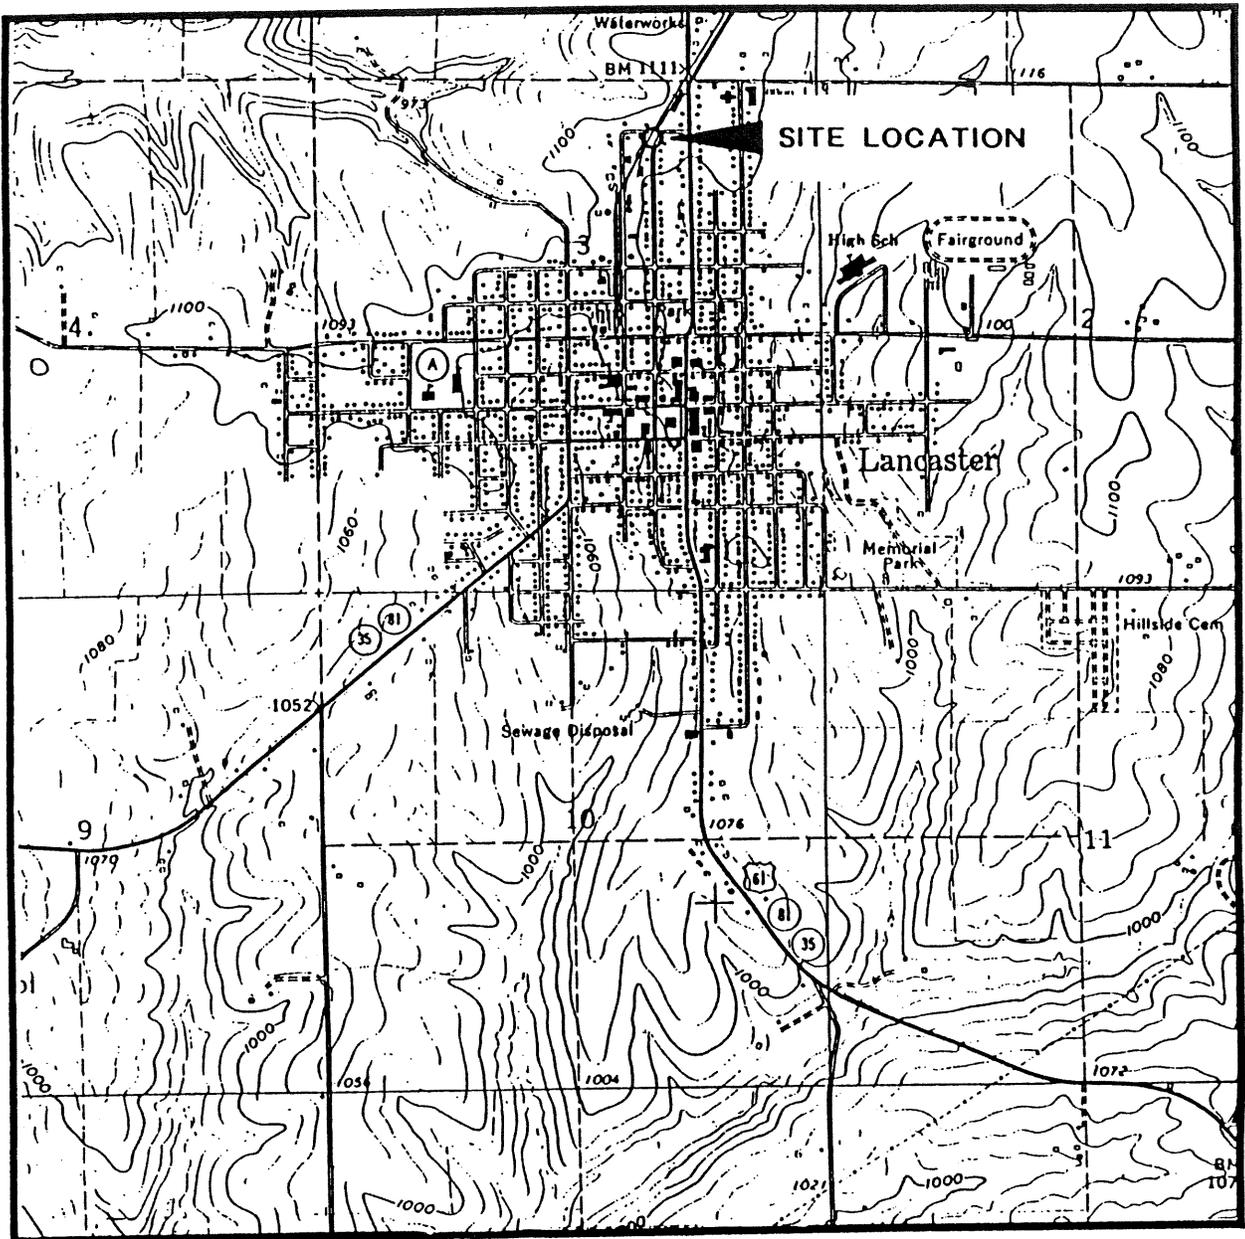

1 : '24000



Lancaster Quadrangle
 Wisconsin - Grant Co.
 7.5 Minute Series (Topographic)
 1962




Figure 1
Site Location

Reuter Oil Company
 Lancaster, Wisconsin

STILES

pre-remedial
soil boring/MW
location map

FOREMOST FARMS
PROPERTY

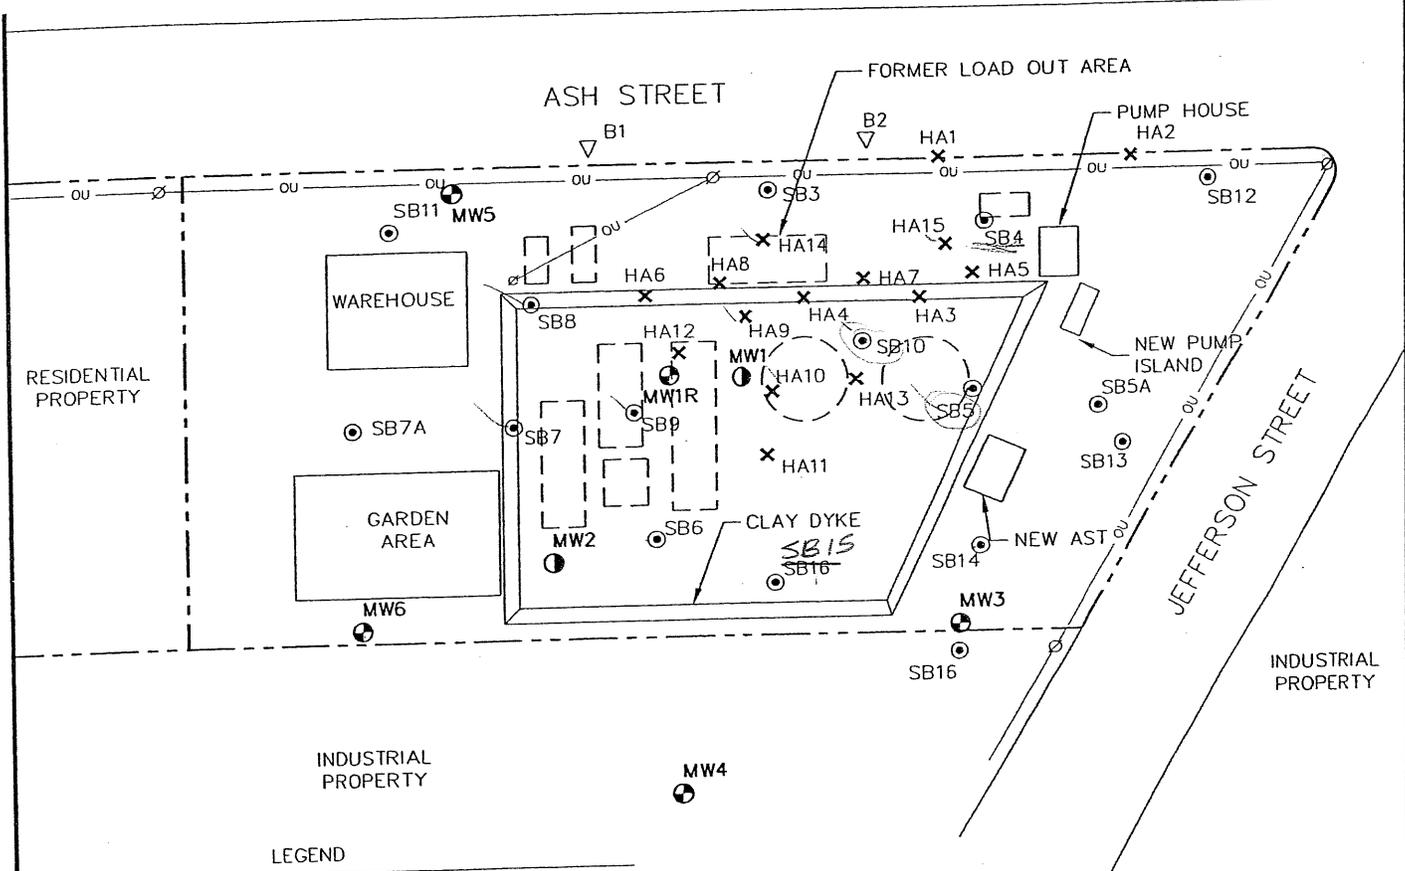


LEGEND

- APPROXIMATE PROPERTY LINE
- ou OVERHEAD UTILITY
- Ø UTILITY POLE
- ⊕ MONITORING WELL
- ⊙ ABANDONED MONITORING WELL
- ⊙ SOIL BORING
- × HAND AUGER
- ▽ CITY OF LANCASTER SOIL BORING
- [- - -] FORMER AST

NOTES:

1. SITE MAP BASED ON MAP PREPARED BY STILES ENVIRONMENTAL, INC.
2. PROPERTY LINES, UTILITY, BORINGS, AND WELL LOCATIONS ARE APPROXIMATE.

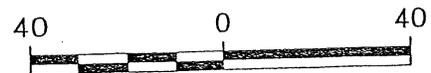

SCALE: 1" = 40'

PROJECT NO. 1876
DRAWN BY: KP/CS
CHECKED BY: RL
DRAWN: 01/11/01
REVISED: 04/03/01

FIGURE 1
SITE MAP
REUTER OIL COMPANY
210 ASH STREET
LANCASTER, WISCONSIN


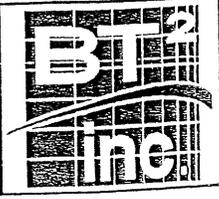


EXHIBIT C

N

FOREMOST FARMS
PROPERTY

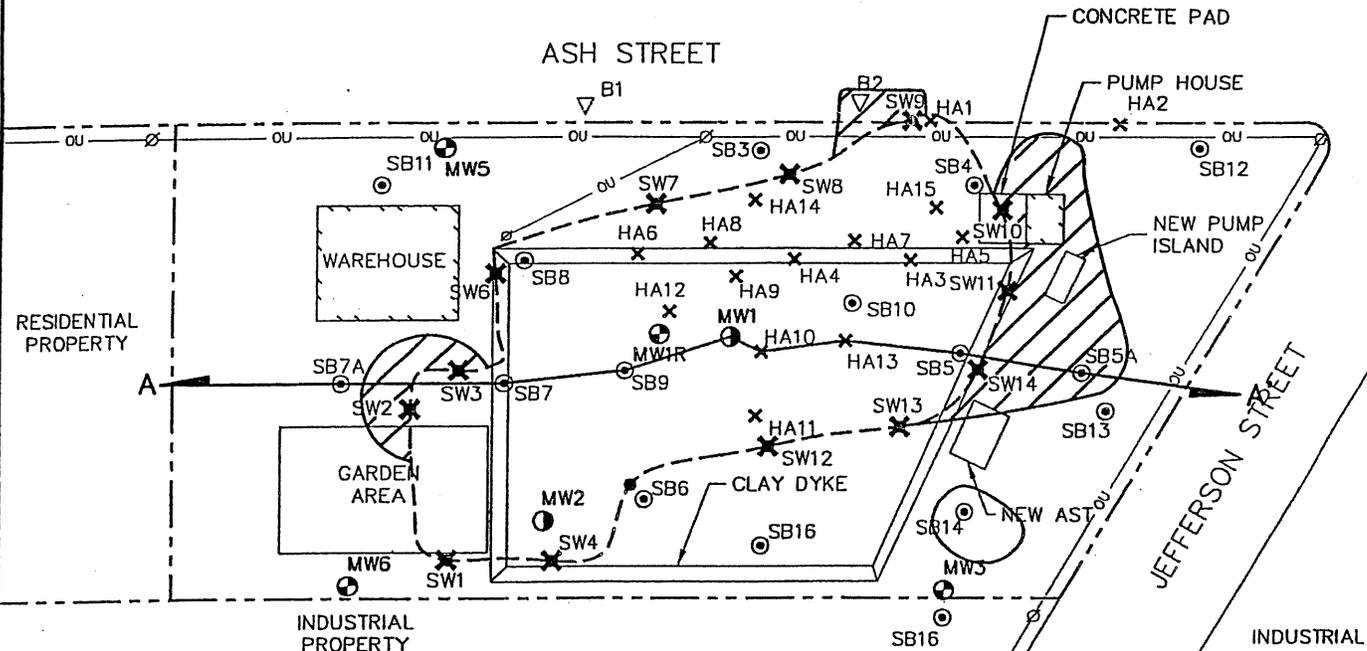


LEGEND

- BOUNDARY OF EXCAVATION
- - - - - APPROXIMATE PROPERTY LINE
- OU OVERHEAD UTILITY
- Ø UTILITY POLE
- ESTIMATED EXTENT OF SOIL CONTAMINATION ABOVE NR 720 SOIL STANDARDS AFTER EXCAVATION.
- MONITORING WELL
- ABANDONED MONITORING WELL
- SOIL BORING
- SIDEWALL SOIL SAMPLE
- HAND AUGER
- CITY OF LANCASTER SOIL BORING

NOTES:


1. SITE MAP BASED ON MAP PREPARED BY STILES ENVIRONMENTAL, INC.
2. PROPERTY LINES, UTILITY, AND WELL LOCATIONS ARE APPROXIMATE.

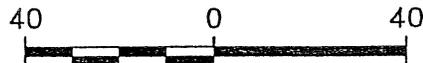


SCALE: 1" = 40'

PROJECT NO. 1876
DRAWN BY: KP/CS
CHECKED BY: RL
DRAWN: 01/11/01
REVISED: 08/21/01


FIGURE 7
POST-REMEDIATION SOIL SAMPLE LOCATION MAP
REUTER OIL COMPANY
210 ASH STREET
LANCASTER, WISCONSIN

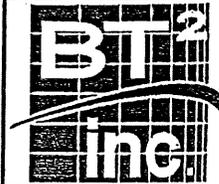

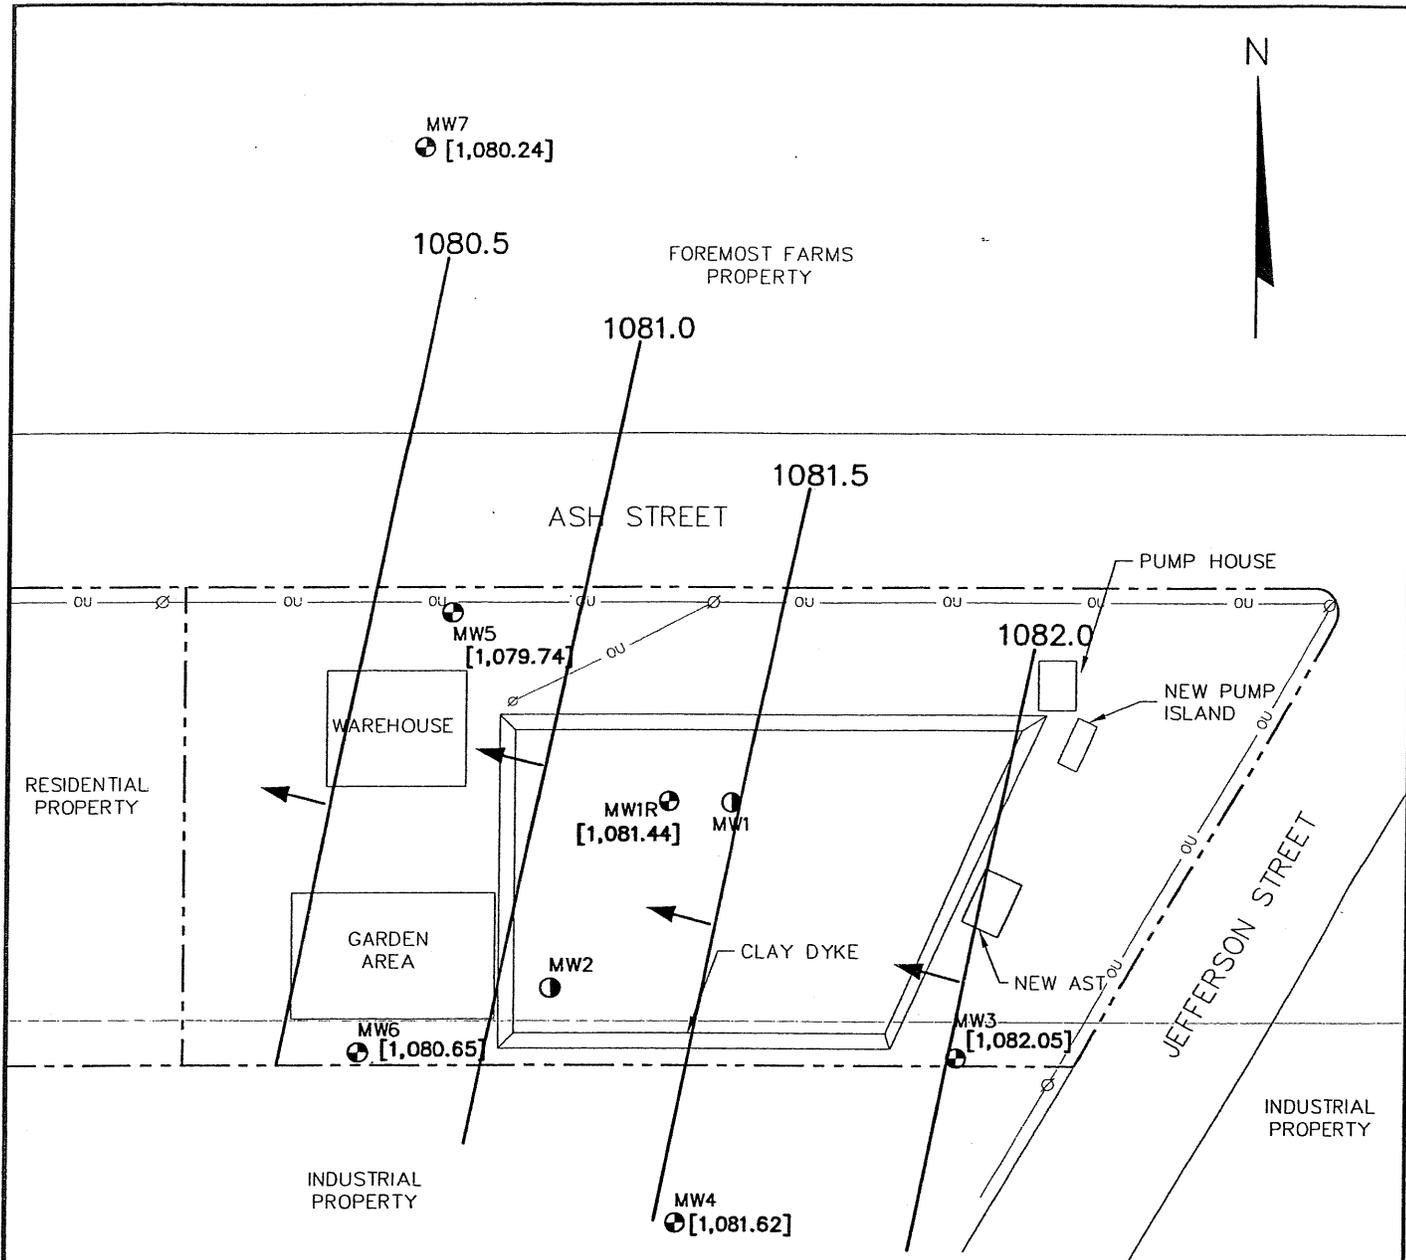

- LEGEND**
- APPROXIMATE PROPERTY LINE
 - ou OVERHEAD UTILITY
 - ∅ UTILITY POLE
 - ⊕ MONITORING WELL
 - ⊙ ABANDONED MONITORING WELL
 - [1,080.65] GROUNDWATER ELEVATION MEASURED ON 12/14/00
 - GROUNDWATER CONTOUR LINE
 - ➔ GROUNDWATER FLOW DIRECTION

- NOTES:**
1. SITE PLAN BASED ON MAP PREPARED BY STILES ENVIRONMENTAL, INC.
 2. PROPERTY LINES, UTILITY, BORINGS, AND WELL LOCATIONS ARE APPROXIMATE.
 3. WATER LEVEL FROM MW5 NOT USED IN THE CONTOUR MAP.

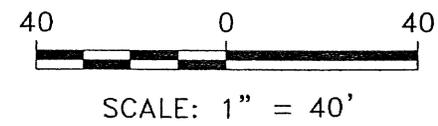

PROJECT NO. 1876
DRAWN BY: KP/CS
CHECKED BY: RL
DRAWN: 01/11/01
REVISED: 04/03/01

FIGURE 4
 WATER TABLE MAP FOR DECEMBER 14, 2000
 REUTER OIL COMPANY
 210 ASH STREET
 LANCASTER, WISCONSIN



Table 2
Post-Remedial Soil Analytical Results Summary
Reuter Oil Co. / Project #1876
 (Results are in µg/kg, except where noted otherwise)

Sample	Date	Depth (feet)	DRO (mg/kg)	GRO (mg/kg)	Benzene	Ethylbenzene	Toluene	Xylenes	1,2,4-TMB	1,3,5-TMB	MTBE
SW1	9/29/98	5	49	12	<31	83	138	238	188	63	<31
SW2	9/29/98	5	1,520	673	<1,520	<1,520	1,520	<4,820	4,060	2,920	<1,520
SW3	9/29/98	5	215	164	<152	<152	<152	<480	<152	<152	<52
SW4	9/29/98	5	<6.4	<6.4	<32	<32	<32	<96	<32	<32	<32
SW5	9/29/98	5	<6.4	<6.4	<32	<32	<32	<96	<32	<32	<32
SW6	9/29/98	5	<6.2	<6.2	<31	<31	<31	<93	<31	<31	<31
SW7	9/29/98	5	8.9	<6.7	<34	<34	<34	<100	<34	<34	<34
SW8	9/29/98	5	10	<6.4	<32	<32	<32	<97	<32	<32	<32
SW9	9/30/98	5	231	365	<150	(6,090)	<150	5,600	15,800	4,750	<150
SW10	9/30/98	5	673	2,740	(31,200)	(78,600)	(178,000)	(238,000)	(91,000)	(23,700)	<1,500
SW11	9/30/98	5	37	129	762	1,680	<39	3,100	3,360	1,290	<32
SW12	9/30/98	5	33	<6.4	<32	<32	<32	<97	<32	<32	<32
SW13	9/30/98	5	<6.5	<6.5	<32	<32	<32	<97	<32	<32	<32
SW14	9/30/98	5	<6.5	<6.5	<32	<32	<32	<97	36	<32	<32
SW15	9/30/98	5	58	70	<31	<31	<31	<94	<70	<151	<31
NR 720 Generic Soil Cleanup Standards			100	100	5.5	2,900	1,500	4,100	NE	NE	NE
NR 746 Table 1 - Indicators of residual petroleum product in soil pores			NE	NE	8,500	4,600	38,000	42,000	83,000	11,000	NE
NR 746 Table 2 - Direct contact standards			NE	NE	1,100	NE	NE	NE	NE	NE	NE

*Samples collected from excavation walls
 excavation extended down to bedrock, therefore
 no floor of excavation samples collected*

Table 2 (Continued)
Post-Remedial Soil Analytical Results Summary

ABBREVIATIONS:

DRO = Diesel Range Organics
MTBE = Methyl-tert-butyl ether

GRO = Gasoline Range Organics
NE = No Standard Established

TMB = Trimethylbenzene

NOTES:

Values in bold exceed NR 720 generic soil cleanup standards.
Values in () exceed NR 746 Table 1 and Table 2 standards.

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Table 3
Groundwater Analytical Results Summary
Reuter Oil Co. / Project #1876
 (Results are in µg/l)

Sample	Date	Lab Notes	DRO	GRO	Benzene	Ethylbenzene	Toluene	Xylenes	TMBs	MTBE	Naphthalene	Lead	Other VOCs
MW1 <i>Pre remedial</i>	11/14/95	--	4,200	22,000	(6,800)	(1,800)	(1,300)	(5,300)	(1,030)	<20	NA	NA	NA
	11/22/95	--	4,400	32,000	(8,700)	(2,500)	(2,100)	(7,400)	(2,190)	(55)	NA	NA	NA
	12/20/95	--	NA	NA	NA	NA	NA	NA	NA	NA	NA	<1.5	NA
	4/21/97	--	3,600	23,000	(5,600)	(1,900)	(310)	(4,900)	(1,100)	(94)	NA	NA	NA
	6/25/97	--	3,900	20,000	(5,900)	(1,500)	150	(3,300)	(960)	<16	NA	NA	NA
	3/10/99	--	AW	AW	AW	AW	AW	AW	AW	AW	AW	AW	AW
MW1R <i>Post remedial</i>	3/18/99	(1)	NA	960	(170)	110	2.1	22	23.4	0.79	3.2	NA	NA
	7/28/99	(2)	NA	NA	(220)	51	3.5	2.4	2.4	<0.70	1.5	NA	NA
	9/23/99	(2)	NA	NA	(210)	77	3.0	3.2	1.7	<0.50	NA	NA	NA
	9/23/99 Dup	(2)	NA	NA	(270)	78	2.8	3.7	1.7	<0.54	NA	NA	NA
	5/10/00	(3)	NA	890	(20)	87	3.6	3.9	3.0	<0.32	NA	NA	NA
MW2	11/14/95	--	940	2,500	(830)	(170)	34	300	(121)	<10	NA	NA	NA
	11/22/95	--	620	2,000	(610)	120	23	170	56	(27)	NA	(3.7)	NA
	12/20/95	--	NA	NA	NA	NA	NA	NA	NA	NA	NA	<1.5	NA
	4/21/97	--	320	730	(190)	52	1.7	4.8	7.4	<0.32	NA	NA	NA
	6/25/97	--	540	530	(11,034)	32	0.99	2.8	5.2	<0.32	NA	NA	NA
	3/18/99	--	AW	AW	AW	AW	AW	AW	AW	AW	AW	AW	AW
MW3	11/14/95	--	<100	<50	(5.2)	1.4	<1.0	<3.0	1.1	<1.0	NA	NA	NA
	11/22/95	--	<100	<50	(2.3)	1.3	<1.0	3.1	<2.0	<1.0	NA	NA	NA
	12/20/95	--	NA	NA	NA	NA	NA	NA	NA	NA	NA	<1.5	NA

AW = abandoned well

Table 3 (Continued)
Groundwater Analytical Results Summary

Sample	Date	Lab Notes	DRO	GRO	Benzene	Ethylbenzene	Toluene	Xylenes	TMBs	MTBE	Naphthalene	Lead	Other VOCs
MW3 (cont.)	4/21/97	--	<100	<50	<0.13	<0.22	<0.20	<0.23	<0.51	<0.16	NA	NA	NA
	6/25/97	--	<100	<50	<0.13	<0.22	<0.20	<0.23	<0.51	<0.60	NA	NA	NA
	10/30/98	--	<100	<50	<0.13	<0.22	<0.20	<0.23	<0.51	<0.60	NA	NA	NA
	3/18/99	--	NA	<50	<0.13	<0.22	<0.20	<0.23	<0.51	<0.16	NA	NA	NA
	7/28/99	--	NA	NA	<0.13	<0.22	<0.20	<0.23	<0.51	<0.16	<0.46	NA	NA
	9/23/99	--	NA	NA	<0.13	0.31	0.32	0.63	<0.51	<0.16	NA	NA	NA
	5/10/00	--	NA	<50	(2.5)	1.5	2.0	3.6	0.52	<0.16	NA	NA	NA
	12/14/00	--	NA	<14	<0.4	<0.4	<0.4	<0.70	<0.4	<0.4	<1.0	NA	NA
MW4	4/21/97	--	<100	<50	<0.13	<0.38	<0.39	<1.1	<0.65	<0.14	<0.35	<89	ND
	6/25/97	--	<100	<50	<0.13	<0.22	<0.20	<0.23	<0.51	<0.16	NA	NA	NA
	10/30/98	--	<100	<50	<0.13	<0.22	<0.20	<0.23	<0.51	<0.16	NA	NA	NA
	3/18/99	--	NA	<50	<0.13	<0.22	<0.20	<0.23	<0.51	<0.16	NA	NA	NA
	7/28/99	--	NA	NA	(0.82)	0.44	<0.20	0.34	<0.51	<0.16	<0.46	NA	NA
	7/28/99 Dup	--	NA	NA	(0.82)	0.44	<0.20	0.31	<0.51	<0.16	NA	NA	NA
	9/23/99	--	NA	NA	<0.13	0.36	0.37	0.85	<0.51	<0.16	NA	NA	NA
	5/10/00	--	NA	<50	(2.0)	1.3	2.6	3.9	0.57	<0.16	NA	NA	NA
MW5 <i>pra</i> <i>post</i>	4/21/97	--	680	4,100	(3,100)	(240)	27	590	(174)	4.6	(26)	<89	Isopropylbenzene 7.8 n-Propylbenzene 12
	6/25/97	--	<100	<50	<0.13	<0.22	<0.20	<0.23	<0.51	<0.16	NA	NA	NA
	10/30/98	--	200	740	(310)	54	33	740	23.9	<1.6	NA	NA	NA
	3/18/99	--	NA	2,100	(980)	(240)	20	180	57.1	<1.6	(19)	NA	NA
	7/28/99	--	NA	NA	(550)	87	4.6	100	36.3	<1.6	(22)	NA	NA

Table 3 (Continued)
Groundwater Analytical Results Summary

Sample	Date	Lab Notes	DRO	GRO	Benzene	Ethylbenzene	Toluene	Xylenes	TMBs	MTBE	Naphthalene	Lead	Other VOCs
MW5 (cont.) <i>post remedial</i>	9/23/99	--	NA	NA	(750)	130	61	170	39.5	<0.80	(12)	NA	NA
	5/10/00	--	NA	6.4	(250)	88	7.3	110	29.3	<1.6	6.4	NA	NA
	12/14/00	(6,7)	NA	250	(66)	23	0.91	9.7	3.5	2.9	3.7	NA	NA
	12/14/00 Dup	(6,7)	NA	260	(66)	23	0.85	9.6	3.4	2.4	4.1	NA	NA
MW6	4/21/97	--	<100	<50	<0.13	<0.38	<0.39	<1.1	<0.65	<0.14	<0.35	<89	ND
	6/25/97	--	<100	<50	<0.13	<0.22	<0.20	<0.23	<0.51	<0.16	NA	NA	NA
	10/30/98	--	<100	<50	<0.13	<0.22	<0.20	0.26	<0.51	<0.16	NA	NA	NA
	3/18/99	--	NA	<50	0.28	<0.22	<0.20	0.38	<0.51	<0.16	NA	NA	NA
	7/28/99	--	NA	NA	<0.13	<0.22	<0.20	<0.23	<0.51	<0.16	<0.46	NA	NA
	9/23/99	--	NA	NA	<0.13	<0.22	<0.20	<0.23	<0.51	<0.16	<0.46	NA	NA
	5/10/00	(4)	NA	<50	(0.55)	0.84	1.3	2.6	0.51	<0.16	NA	NA	NA
	12/14/00	--	NA	<14	<0.4	<0.4	<0.4	<0.7	<0.4	<0.4	<1.0	NA	NA
MW7	5/10/00	--	NA	<50	(3.1)	2.4	3.7	6.5	1.32	<0.16	NA	NA	NA
	12/14/00	--	NA	<14	<0.4	<0.4	<0.4	<0.7	<0.4	<0.4	<1.0	NA	NA
Trip Blank	7/28/99	--	NA	NA	<0.13	<0.22	<0.20	<0.23	<0.51	<0.16	NA	NA	NA
	9/23/99	--	NA	NA	<0.13	<0.22	<0.20	<0.23	<0.51	<0.16	NA	NA	NA
	5/10/00	(5)	NA	63	<0.13	<0.22	<0.20	5.8	5.4	1.0	NA	NA	NA
	12/14/00	--	NA	<14	<0.4	<0.4	<0.4	<0.7	<0.4	<0.4	<1.0	NA	NA
NR 140 Enforcement Standards			NE	NE	5	700	1,000	10,000	480	60	40	15	
NR 140 Preventive Action Limits			NE	NE	0.5	140	200	1,000	96	12	8	1.5	

Table 3 (Continued)
Groundwater Analytical Results Summary

ABBREVIATIONS:

DRO = Diesel Range Organics
VOCs = Volatile Organic Compounds
AW = Abandoned Well

GRO = Gasoline Range Organics
NA = Not Analyzed

TMB = 1,2,4- and 1,3,5-Trimethylbenzene
ND = Not Detected

MTBE = Methyl-tert-butyl ether
NE = No Standard Established

NOTES:

All groundwater samples taken after 1998 are post soil remediation samples.
Groundwater sampling prior to December 14, 2000 was conducted by Stiles Environmental, Inc.
Values in **Bold** exceed NR 140 enforcement standards.
Values in () exceed NR 140 preventive action limits.

LABORATORY NOTES:

- (1) MW1R is the replacement of MW1.
- (2) MTBE analysis - Matrix interference.
- (3) GRO analysis - Late eluting hydrocarbons present.
- (4) PVOCs analysis - Improperly preserved sample.
- (5) PVOCs analysis - Result confirmed via re-analysis.
- (6) Significant peaks detected outside GRO chromatographic window.
- (7) Benzene calibration criteria exceeded.

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1/22/01

Table 4
Groundwater Monitoring Results for Natural Attenuation Evaluation
Reuter Oil Co. / Project #1876

Sample	Date	Dissolved Oxygen (mg/l)	Redox (mV)	Conductivity (ohms)	Nitrate + Nitrite Nitrogen (mg/l as N)	Iron (mg/l)	Sulfate (mg/l)	pH (Std. Units)
MW3 (Upgradient)	3/18/99	3.26	117.8	1,090	1.4	5.9	63	6.37
	7/28/99	1.43	158	720	<0.024	0.75	61	6.80
	9/23/99	3.15	164.1	1,090	1.0	6.2	64	6.70
	5/10/00	1.78	108.2	600	2.0	14	59	8.06
	12/14/00	6.8	NM	999	1.52	<0.012*	53.1	6.78
MW5 (Within plume)	3/18/99	0.24	150.5	980	0.35	12	63	6.96
	7/28/99	0.71	15	650	1.2	8.0	66	6.62
	9/23/99	0.53	13.9	1,030	0.33	2.6	69	6.64
	5/10/00	0.40	-132.1	290	0.76	3.2	67	7.30
	12/14/00	3.4	NM	874	<0.08	0.880*	23.9	6.50
MW6 (Sidegradient)	3/18/99	2.61	172.4	960	1.8	11	71	7.21
	7/28/99	2.43	217	650	3.0	12	65	6.75
	9/23/99	2.08	189.4	810	1.8	22	67	6.79
	5/10/00	2.07	133.7	220	1.8	8.3	54	7.16
	12/14/00	3.1	NM	891	1.75	0.0250*	52.7	6.70
MW7 (Sidegradient)	5/10/00	6.03	123.8	NM	2.2	2.3	63	6.88
	12/14/00	3.0	NM	1027	4.19	<0.012*	79.1	6.82

ABBREVIATIONS:

NA = Not analyzed

NM = Not measured

Redox = Oxidation-reduction potential

NOTES:

Groundwater sampling prior to December 14, 2000 was conducted by Stiles Environmental, Inc.
 Iron results prior to 12/14/00 indicate total concentrations. 12/14/00 results indicate dissolved concentrations.
 Dissolved oxygen (DO), Redox, conductivity, and pH measured using field instrumentation.



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Environmental Engineering and Science

August 21, 2001

Mr. Jerry Carroll
Lancaster Department of Public Works
206 South Madison Street
Lancaster, WI 53813

**SUBJECT: Reuter Oil
210 Ash Street, Lancaster, Wisconsin
BT² Project #1876**

Dear Mr. Carroll:

We are writing to you on behalf of our client, Mr. Myron Reuter, to inform you of the presence of petroleum-impacted soil identified in the right-of-way adjacent to the Reuter Oil property at 210 Ash Street, Lancaster, Wisconsin (please see the attached figure). This notification of residual soil contamination is required under Wisconsin Administrative Code (WAC) Chapter NR 726.05(2)(b)4.

In July 1994, contamination was discovered at the Reuter Oil property during an above ground tank closure assessment. The Wisconsin Department of Natural Resources (WDNR) was notified of the petroleum release and subsequently directed cleanup activities for the site. The majority of impacted soil was removed in July of 1998. However, a small amount of impacted soil remains at locations not accessible or practicable for excavation (e.g., under Ash Street).

Residual soil contamination remains under Ash Street in the vicinity of soil boring B2. Boring B2 was installed by the City of Lancaster in December 1994. Soil analyzed from this boring was found to contain the petroleum constituent benzene at a concentration of 150 parts per billion (ppb). This concentration exceeds the residual contaminant level for benzene defined in WAC Chapter NR 720.09 (5.5 ppb). Other petroleum constituents, including gasoline range organics (GRO), ethylbenzene, and trimethylbenzenes were also detected in soil at boring B2 at concentrations below Chapter NR 720 residual contaminant levels.

The WDNR is allowing site closure for the Reuter Oil property under WAC Chapter NR 726.05 in part because soil contamination in the Ash Street right-of-way is not considered an existing or anticipated threat to public health, safety, or welfare.


Please feel free to contact us at 608-224-2830 if you have any questions or concerns regarding this letter.

Sincerely,
BT² Inc.

Robert E. Langdon
Project Hydrogeologist

Betty J. Socha, P.G.
Project Manager

UNITED STATES POSTAL SERVICE

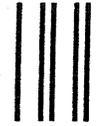

Official Business

PENALTY FOR PRIVATE USE TO AVOID PAYMENT OF POSTAGE, \$300

Print your name, address and ZIP Code here

BT2, INC.
2830 DAIRY DRIVE
MADISON, WI 53718-6751

ATT: Rob L

Is your RETURN ADDRESS completed on the reverse side?

SENDER:

- Complete items 1 and/or 2 for additional services.
- Complete items 3, and 4a & b.
- Print your name and address on the reverse of this form so that we can return this card to you.
- Attach this form to the front of the mailpiece, or on the back if space does not permit.
- Write "Return Receipt Requested" on the mailpiece below the article number.
- The Return Receipt will show to whom the article was delivered and the date delivered.

I also wish to receive the following services (for an extra fee):

- 1. Addressee's Address
- 2. Restricted Delivery

Consult postmaster for fee.

3. Article Addressed to:

7001 1140 0001 1564 3668

Jerry Carroll
Lancaster Dept of Public Works
206 So Madison Street
Lancaster WI 53813

4b. Service Type

- Registered Insured
- Certified COD
- Express Mail Return Receipt for Merchandise

7. Date of Delivery

8-24-01

5. Signature (Addressee)

[Handwritten Signature]

6. Signature (Agent)

8. Addressee's Address (Only if requested and fee is paid)

Thank you for using Return Receipt Service.