

## GIS REGISTRY INFORMATION

<b>SITE NAME:</b>	Parkside Service Center			<b>FID #</b>	
<b>BRRTS #:</b>	03-43-151736			(if appropriate):	
<b>COMMERCE #:</b>	54149-9701-46-A				
<b>CLOSURE DATE:</b>	January 25, 2007				
<b>STREET ADDRESS:</b>	13946 State Highway 32/64				
<b>CITY:</b>	Mountain				
<b>SOURCE PROPERTY GPS COORDINATES</b> (meters in WTM91 projection):	<b>X =</b>	640089		524476	
<b>CONTAMINATED MEDIA:</b>	Groundwater	<input type="checkbox"/>	Soil	<input type="checkbox"/>	Both <input checked="" type="checkbox"/>
<b>OFF-SOURCE GW CONTAMINATION &gt;ES:</b>		Yes	<input type="checkbox"/>	No	<input checked="" type="checkbox"/>
• <b>IF YES, STREET ADDRESS:</b>					
• <b>GPS COORDINATES</b> (meters in WTM91 projection):	<b>X =</b>		<b>Y =</b>		
<b>OFF-SOURCE SOIL CONTAMINATION</b> >Generic or Site-Specific RCL (SSRCL):	Yes	<input checked="" type="checkbox"/>	No	<input type="checkbox"/>	
• <b>IF YES, STREET ADDRESS 1:</b>	Parcel to the south				
• <b>GPS COORDINATES</b> (meters in WTM91 projection):	<b>X =</b>	640119	<b>Y =</b>	524464	
<b>CONTAMINATION IN RIGHT OF WAY:</b>	Yes	<input type="checkbox"/>	No	<input checked="" type="checkbox"/>	
<b><u>DOCUMENTS NEEDED</u></b>					
Closure Letter, and any conditional closure letter issued or denial letter issued					<input checked="" type="checkbox"/>
Copy of any maintenance plan referenced in the final closure letter					<input checked="" type="checkbox"/>
Copy of (soil or land use) deed notice <i>if any required as a condition of closure</i>					<input type="checkbox"/> NA
Copy of most recent deed, including legal description, for all affected properties					<input checked="" type="checkbox"/>
Certified survey map or relevant portion of the recorded plat map <i>(if referenced in the legal description)</i> for all affected properties					<input checked="" type="checkbox"/>
County Parcel ID number, <i>if used for county</i> , for all affected properties					<input checked="" type="checkbox"/>
<b>Location Map</b> that outlines all properties within contaminated site boundaries on USGS topographic map or plat map in sufficient detail to permit the parcels to be located easily. If groundwater standards are exceeded, the map must also include the location of all municipal and potable wells within 1200' of the site.					<input checked="" type="checkbox"/>
<b>Detailed Site Map(s) for all affected properties</b> , showing buildings, roads, property boundaries, contaminant sources, utility lines, monitoring wells and potable wells. This map shall also show the location of all contaminated public streets, highway and railroad rights-of-way in relation to the source property and in relation to the boundaries of groundwater contamination exceeding ch. NR 140 ESs and soil contamination exceeding ch. NR 720 generic or SSRCLs.					<input checked="" type="checkbox"/>
Tables of Latest Groundwater Analytical Results (no shading or cross-hatching)					<input checked="" type="checkbox"/>
Tables of Latest Soil Analytical Results (no shading or cross-hatching)					<input checked="" type="checkbox"/>
Isoconcentration map(s), <i>if required for site investigation (SI)</i> . The isoconcentration map should have flow direction and extent of groundwater contamination defined. If not available, include the latest extent of contaminant plume map.					<input checked="" type="checkbox"/>
GW: Table of water level elevations, with sampling dates, and free product noted if present					<input checked="" type="checkbox"/>
GW: Latest groundwater flow direction/monitoring well location map (should be 2 maps if maximum variation in flow direction is greater than 20 degrees)					<input checked="" type="checkbox"/>
SOIL: Latest horizontal extent of contamination exceeding generic or SSRCLs, with one contour					<input checked="" type="checkbox"/>
Geologic cross-sections, <i>if required for SI</i>					<input checked="" type="checkbox"/>
RP certified statement that legal descriptions are complete and accurate					<input checked="" type="checkbox"/>
Copies of off-source notification letters (if applicable)					<input checked="" type="checkbox"/>
Letter informing ROW owner of residual contamination (if applicable) (public, highway or railroad ROW)					<input type="checkbox"/> NA



ENVIRONMENTAL & REGULATORY SERVICES DIVISION  
BUREAU OF PECFA  
2129 Jackson Street  
Oshkosh, Wisconsin 54901-1805  
TDD #: (608) 264-8777  
Fax #: (920) 424-0217  
Jim Doyle, Governor  
Mary P. Burke, Secretary

January 25, 2007

Mr. Michael Beth  
14048 Highway 32  
PO Box 132  
Mountain, WI 54149

RE: **Final Closure with Land Use Limitation**

**Commerce # 54149-9701-46-A** DNR BRRTS # 03-43-151736  
Parkside Service Center, 13946 State Highway 32/64, Mountain

Dear Mr. Beth:

The Wisconsin Department of Commerce (Commerce) has determined that this site does not pose a significant threat to the environment and human health as long as current and subsequent property owner(s) adhere to the following limitations:

The barrier cap must be maintained in accordance with the enclosed maintenance plan.

Commerce has the authority per section 292.12(2), Wis. Stats., to require the maintenance of a barrier cap at this property. Failure to adhere to this limitation may result in financial penalties from \$10 to \$5,000 per day in accordance with section 292.99(1), Wis. Stats. Commerce may conduct inspections to ensure compliance with the maintenance plan. In the future, you may request that Commerce review new information to determine if the cap requirement can be changed or removed.

This site is now listed as "closed" on the Commerce database and will be included on the Department of Natural Resources (DNR) Geographic Information System (GIS) Registry of Closed Remediation Sites to address residual soil and groundwater contamination. It is in your best interest to keep all documentation related to the environmental activities at your site.

Please note that if contaminated soil is excavated in the future, it must be managed in accordance with all applicable state and federal regulations. If it is determined that any remaining contamination poses a threat, the case may be reopened and further investigation or remediation may be required.

Thank you for your efforts to protect Wisconsin's environment. If you have any questions, please contact me in writing at the letterhead address or by telephone at (920) 303-5410.

Sincerely,

Beth A. Erdman  
Senior Hydrogeologist  
Site Review Section

Enclosure

cc: Allan Wolfe-Shaw Environmental, Inc.



Shaw Environmental & Infrastructure, Inc.

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September 26, 2006

Ms. Beth Erdman  
Wisconsin Department of Commerce  
2129 Jackson Street  
P.O. Box 10448  
Oshkosh, Wisconsin 54901

Re: Cap Maintenance Plan  
Former Parkside Service Center Site  
13946 State Hwy 32-64  
Mountain, Wisconsin  
WDNR BRRTS# 03-43-151736  
PECFA ID # 54149-9701-46

Dear Ms. Erdman:

The following constitutes a Cap Maintenance Plan for the referenced property. The Cap Maintenance Plan serves as the final remedy to address the residual petroleum soil contamination. Currently the shallow residual soil contamination is covered by an asphalt driveway and parking area. It will be the responsibility of the property owner to inspect the barrier cap on an annual basis and oversee maintenance to insure direct contact with residual shallow soil contamination is not possible. In addition, the Wisconsin Department of Natural Resources will be contacted by the property owner prior to conducting the following activities: (1) Excavating or grading of the land surface; (2) Filling on capped areas and areas with impervious surfaces; (3) Plowing for agricultural cultivation; and (4) Construction or installation of a building or other structure with a foundation that would sit on or be placed within the cap or impervious surface.

If you should have any questions or require additional information please contact Mark Bergeon at (920)497-8910.

Sincerely,

Nicholas Glander  
Environmental Specialist

Cc: Michael Beth



ENVIRONMENTAL & REGULATORY SERVICES DIVISION  
BUREAU OF PECFA  
2129 Jackson Street  
Oshkosh, Wisconsin 54901-1805  
TDD #: (608) 264-8777  
Fax #: (920) 424-0217  
Jim Doyle, Governor  
Mary P. Burke, Secretary

September 27, 2006

Mr. Michael Beth  
14048 Highway 32  
PO Box 132  
Mountain, WI 54149

RE: **Case Closure Consideration with Proposed Land Use Limitation**

**Commerce # 54149-9701-46** DNR BRRTS # 03-43-151736  
Parkside Service Center, 13946 State Highway 32/64, Mountain

Dear Mr. Beth:

The Wisconsin Department of Commerce (Commerce) has reviewed the request for case closure prepared by your consultant, Shaw Environmental, Inc., for the site referenced above. It is understood that residual soil and groundwater contamination remain on site. This letter serves as written notice that no further investigation or remedial action is necessary.

### **Abandonment Requirements**

Monitoring wells MW-1 through MW-9 and observation well OW-1 must be properly abandoned within 60 days and the appropriate documentation (WDNR Abandonment Form 3300-5B) forwarded to Commerce at the letterhead address within 120 days of the date of this letter. Noncompliance with the abandonment requirement and deadline can result in enforcement action and financial penalties. A final closure letter will be sent after the abandonment requirements have been met.

### **Land Use Limitation Requirement**

Commerce has determined that this site does not pose a significant threat to the environment and human health as long as the barrier cap at this property is maintained. Residual petroleum concentrations in soil exceeding standards for the protection of human health from direct contact with contaminated soil remain in the vicinity of monitoring well MW-3. Therefore, the existing barrier cap must be maintained in accordance with the maintenance plan provided to prevent direct contact with shallow contaminated soil. A site figure that indicates the approximate area with shallow residual petroleum contamination in soil and the barrier cap maintenance plan are enclosed for your review.

This limitation must be adhered to by the current property owner and any subsequent owner. Failure to adhere to this restriction may result in financial penalties from \$10 to \$5,000 per day in accordance with section 292.99(1), Wis. Stats.

Acceptance of the limitation to be imposed on the property makes it unnecessary to conduct additional soil remediation activities on the property at this time. In the future, you may request that Commerce review any new information to determine if the barrier requirement or maintenance plan can be changed or removed. If you do not want this limitation on your property, you must contact the undersigned to determine what

remedial activities will be required, at your own expense, to close this case without the cap maintenance requirement.

**Claim Submittal Requirement**

Timely filing of your final PECFA claim (if applicable) is encouraged. If your claim is not received within 120 days of the date of this letter, interest costs incurred after 60 days of the date of this letter will not be eligible for PECFA reimbursement (section 101.143(4)(cc)1.a., Wis. Stats.).

Thank you for your efforts to protect Wisconsin's environment. If you have any questions, please contact me in writing at the letterhead address or by telephone at (920) 303-5410.

Sincerely,



Beth A. Erdman  
Senior Hydrogeologist  
Site Review Section

Enclosure

cc: Mark Bergeon-Shaw Environmental, Inc.  
Mark Soletske-Current Owner



Shaw Environmental & Infrastructure, Inc.

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September 26, 2006

Ms. Beth Erdman  
Wisconsin Department of Commerce  
2129 Jackson Street  
P.O. Box 10448  
Oshkosh, Wisconsin 54901

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Former Parkside Service Center Site  
13946 State Hwy 32-64  
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If you should have any questions or require additional information please contact Mark Bergeon at (920)497-8910.


Sincerely,

Nicholas Glander  
Environmental Specialist

Cc: Michael Beth

**LEGEND**

- - - PROPERTY
- ⊙ POTABLE WELL
- FORMER UST CAVITY
- ⊙ SEPTIC
- ⊕ MONITORING WELL
- ⊗ OBSERVATION WELL
- OE- OVERHEAD ELECTRIC
- GAS- UNDERGROUND GAS
- ⊕ UTILITY POLE
- FO- FIBER OPTIC

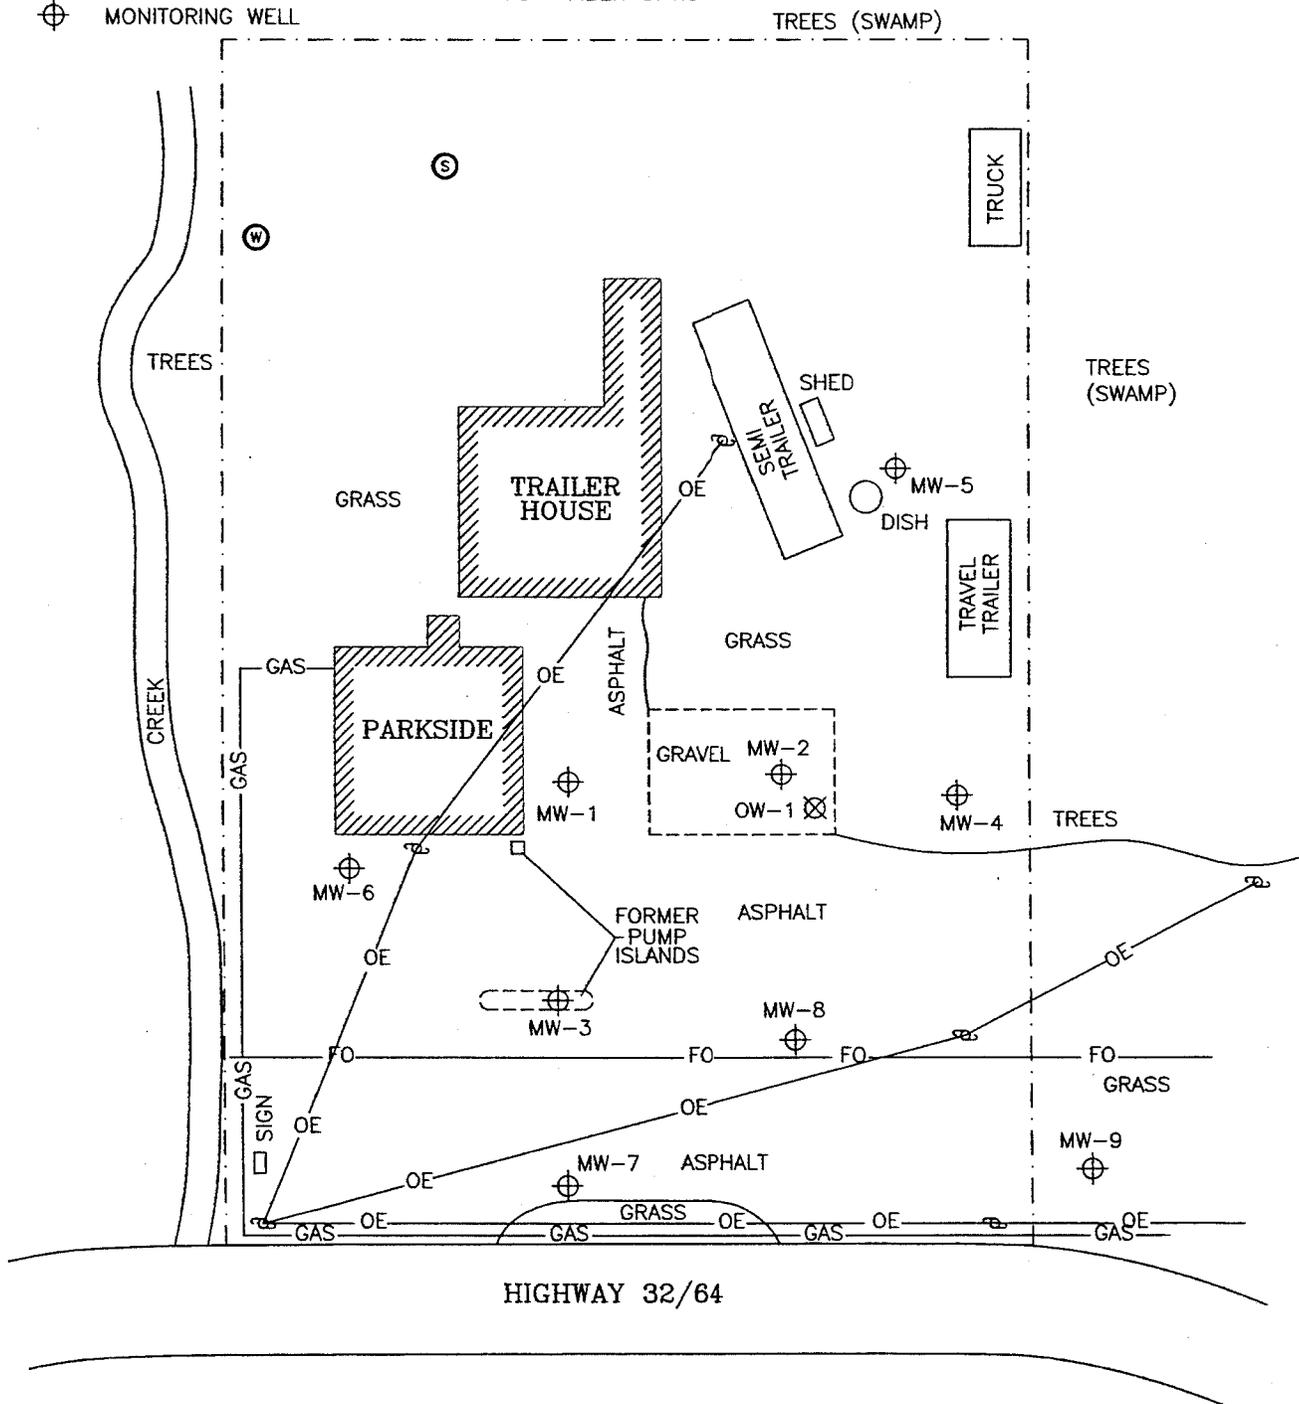

REV	DATE	BY	CHK'D	APR'VD	DESCRIPTION/ISSUE

 <b>Shaw E &amp; I, Inc.</b>	FORMER PARKSIDE SERVICE CENTER SITE MOUNTAIN, WISCONSIN			
	FIGURE 1 SITE PLAN VIEW			
DESIGNED BY	KFK	07/26/05	CHECKED BY	
DRAWN BY	KFK	07/26/05	APPROVED BY	
SIZE:	SCALE:	DRAWING NO.	SHEET NO.	REVISION NO.
A	1" = 30'	970198G1	1 OF 1	0

475762

DOCUMENT NO.

STATE BAR OF WISCONSIN FORM 2 -- 1988

WARRANTY DEED

Michael E. Beth, a single person

conveys and warrants to Mark A. Soletske and Sheila M. Soletske, his wife, as survivorship martial property.

the following described real estate in Oconto County, State of Wisconsin:

VOL 771 PAGE 969

REGISTER OF DEEDS

OCONTO COUNTY

AT 9 O'CLOCK AM

MAY 11 1999

Sandra Harley REGISTER

RETURN TO Mark Soletske 114221 Schacht Rd. Marinette, WI 54143

029 - 77110790LC6

Parcel Identification Number (PIN):

A part of the SW 1/4 of the NW 1/4 of Section 11, Township 31 North, Range 16 East, in the Village of Mountain, Oconto County, Wisconsin, more particularly described as follows to-wit: Commencing at the NE corner of Lot 5, Block 3 of Frost Addition to the Village of Mountain; thence South 44° East a distance of 177 feet to the iron pipe on the East side of the town creek in the SW 1/4 of the NW 1/4 Section 11, Township 31 North, Range 16 East, wch is the point of beginning, thence continuing on a bearing of South 44° East a distance of 171 feet to an iron pipe, thence South 46° 36 minutes West a distance of 124.8 feet to the town road right of way, thence North 43° and 30 minutes West along the road right of way a distance of 90 feet to the town creek, thence Northeasterly along the town creek a distance of 153 feet more or less to the point of beginning. Containing .40 hundredths of an acre more or less. Above described property being a part of Outlot C, Frosts Addition to the Village of Moutain.

This is homestead property. (is) (is not)

WIS. TRANSFER FEE \$ 126.00 OCONTO CO.

Exception to Warranties:

Dated this 10th day of January, 1999

(SEAL) Michael E. Beth (SEAL)

Michael E. Beth

(SEAL) (SEAL)

AUTHENTICATION

ACKNOWLEDGMENT

Signature(s)

STATE OF WISCONSIN

authenticated this day of 1999

Oconto County, ss.

Personally came before me this 10th day of January, 1999 the above named Michael E. Beth

TITLE: MEMBER STATE BAR OF WISCONSIN

(If not authorized by § 706.06, Wis. Stats.) THIS INSTRUMENT WAS DRAFTED BY Mary Elaine Niemann

to me known to be the person who executed the foregoing instrument and acknowledge the same.

Mary Elaine Niemann

Mary Elaine Niemann Notary Public Oconto County, Wis. My Commission is permanent. (If not, state expiration date: August 12, 2001)

(Signatures may be authenticated or acknowledged. Both are not necessary.)

Names of persons signing in any capacity should be typed or printed below their signatures.

WARRANTY DEED

STATE BAR OF WISCONSIN Form No. 2 -- 1988

832 NTF 0821A Helco, Inc., P.O. Box 10208, Green Bay, WI 54307-0208

This Indenture, Made this 31st day of July A. D., 1995 between the County of Oconto, State of Wisconsin, party of the first part, and Michael Gauthier, a single individual of 155 Jackson Street, Oconto Falls, WI 54154

THIS SPACE RESERVED FOR RECORDING DATA

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RETURN TO

LAND INFO SYSTEMS

part y of the second part.

WITNESSETH, That whereas the Board of Supervisors of the County of Oconto, State of Wisconsin, at a regular meeting held on the 18th day of April A.D., 1995 passed the following resolution and orders: That the County Clerk be authorized and directed to sell the land hereinafter mentioned for \$51.00 ; terms to be cash on delivery of deed.

AND WHEREAS, the said party of the second part has presented to the County Clerk of said County the sum of \$51.00 for the purchase of the following described tract of land situated in the County of Oconto, Wisconsin, to wit:

TOWN OF ARMSTRONG PARCEL# 004-77-11077P;C4

That part of Outlot C in the Village of Mountain, Commencing at the Southwest corner of Lot One (1) in Block Three (3) of Frost Addition to the Village of Mountain, thence running Northeast 125 feet along South line along said lot; thence running Southeast about 15 feet to the Town Creek, thence running South about 161 feet along said Creek to Highway 32, thence northerly along said Highway 78 feet to point of beginning.

EXEPT FROM TRANSFER FEE AND FORM PER 77.25(2)

NOW, THEREFORE, the said Oconto County in consideration of the payment the money aforesaid, and by virtue of the said resolution and orders does hereby quitclaim to the said Michael Gauthier, a single individual the lands above described.

IN TESTIMONY WHEREOF, I have executed this deed pursuant to and by virtue of the authority in me vested by the foregoing resolution and by the statutes of the State of Wisconsin and for and in behalf of the County of Oconto aforesaid, and hereunto subscribe my name officially, and have affixed my seal and the seal of Oconto County the day and year first above written.

SIGNED AND SEALED IN PRESENCE OF

Oconto County (SEAL)

430000 REGISTER OF DEEDS OCONTO COUNTY AT 9 O'CLOCK PM

Rose Stellmacher County Clerk, Oconto County, Wis.

AUG 4 1995

State of Wisconsin } Oconto County

ss. Loralee Lasky REGISTER

Be it remembered, that on this 4th day of August, 1995 personally appeared before me the above named Rose Stellmacher County Clerk of Oconto County, Wisconsin, to me known to be such, and to be the person who executed the foregoing deed, and acknowledge that she executed the same and to be her free act and deed and the free act and deed of said Oconto County for the uses and purposes therein expressed.

NOTARY SEAL.


Oconto County

This instrument drafted by

Shelley Strang Notary Public, Oconto County, Wis.

Robert J. Mraz

My Commission (Expires) 8-25-98

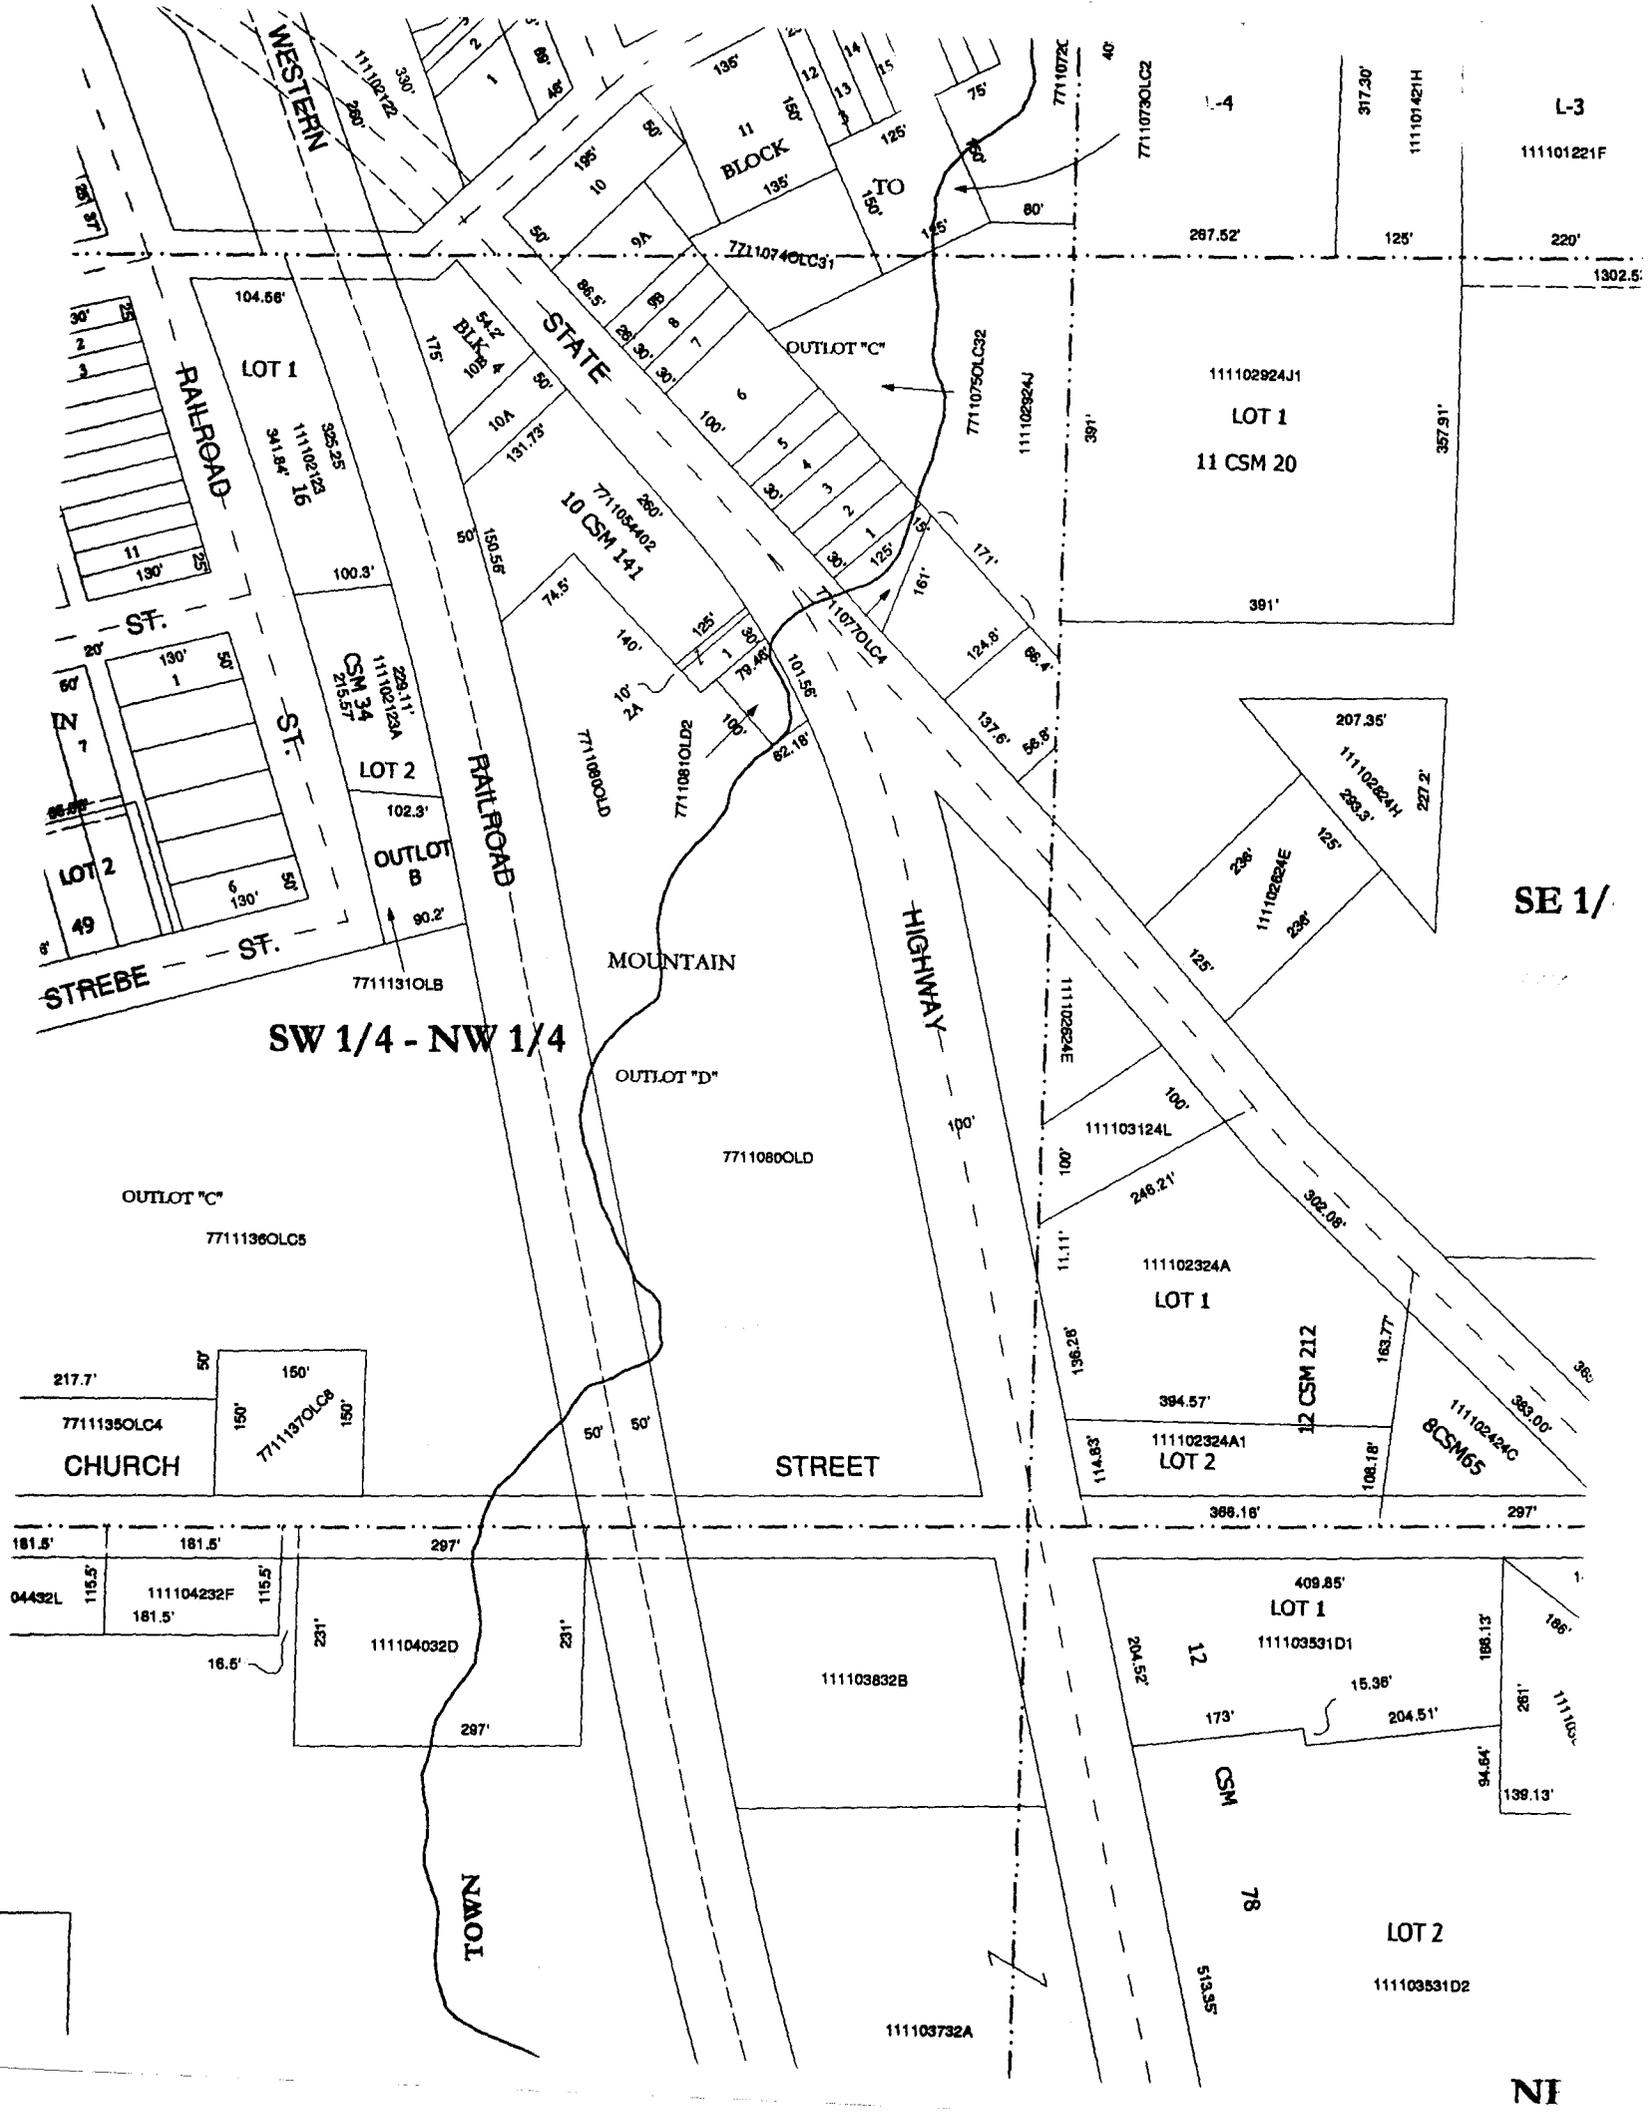

SW 1/4 - NW 1/4

SE 1/4

L-3

111101221F

111102924J1  
LOT 1  
11 CSM 20

111102924H  
299.3'  
227.2'

111102324A  
LOT 1  
394.57'

111102324A1  
LOT 2

12 CSM 212

111102494C  
8CSM65

LOT 1  
111103531D1

LOT 2  
111103531D2

RAILROAD  
LOT 1  
111102125A  
311.94'

ST.  
LOT 2  
111102125A  
229.11'

BLOCK  
11  
135'

STATE  
10 CSM 141  
7711034402

MOUNTAIN


CHURCH  
77111350LC4

STREET

TOWN

111103732A

NI

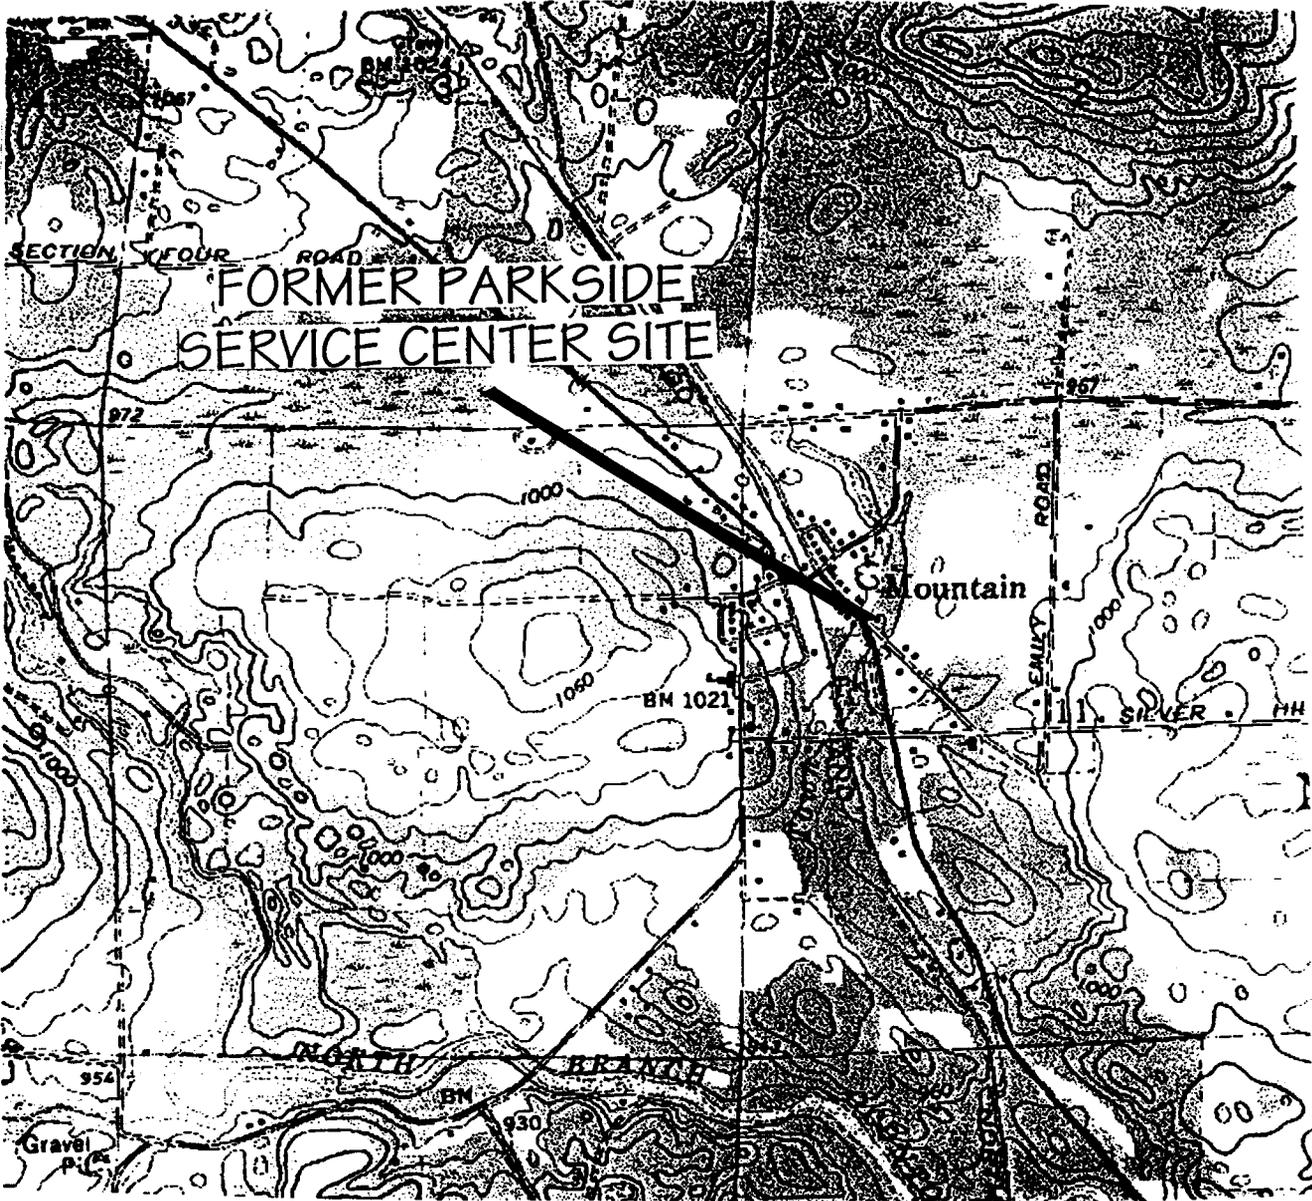


(USGS 1973)  
MOUNTAIN QUADRANGLE



LOCATION

SCALE  
1:24000

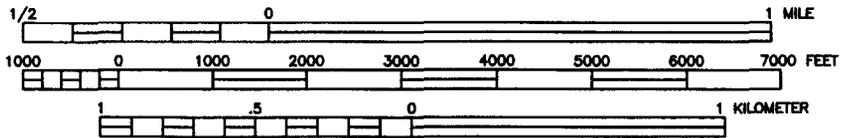

CONTOUR INTERVAL 10 FEET



		FORMER PARKSIDE SERVICE CENTER SITE MOUNTAIN, WISCONSIN			
		<p align="center">FIGURE 1 SITE LOCATION MAP</p>			
DESIGNED BY	KFK	12/14/04	CHECKED BY		
DRAWN BY	KFK	12/14/04	APPROVED BY		
SIZE:	SCALE:	DRAWING NO.	SHEET NO.	REVISION NO.	
A	AS SHOWN	970198.101	1 OF 1	0	

REV	DATE	BY	CHK'D/APPR'D	DESCRIPTION/ISSUE



**TABLE 4**  
**Geoprobe Boring Groundwater Sample Laboratory Analytical Results**  
**Former Parkside Service Center Site**  
**Mountain, Wisconsin**

Well	Sample Date	Benzene	Ethyl-benzene	Toluene	Total Xylenes	1,2,4-TMB	1,3,5-TMB	MTBE
GP-1	12/20/01	<b>64</b>	130	20	1,000	<b>1,000</b>	<b>210</b>	<4.6
GP-2	12/20/01	<b>30</b>	<0.22	<0.41	<0.69	0.47	<0.34	45
GP-4	12/20/01	<b>17</b>	<4.4	<8.2	38	200	41	<9.2
GP-5	12/20/01	<0.21	<0.22	<0.41	<0.69	0.66	<0.34	10
GP-6	12/20/01	<2.1	19	<4.1	150	180	58	7.1
GP-8	12/20/01	<b>620</b>	67	<4.1	260	160	18	45
NR 140 ES		5	343	1,000	10,000	480*		60
NE 140 PAL		0.5	68.6	200	1,000	96*		12

Notes: All results are reported in ppb, unless otherwise noted

**BOLD** indicates value equals or exceeds the NR 140 Enforcement Standards.

*ITALICS* indicates value equals or exceeds the NR 140 Preventive Action Limit.

(\*): NR 140 Enforcement Standard and NR 140 Preventive Action Limit based on total TMB concentrations.

TMB: Trimethylbenzene  
 MTBE: Methyl t-butyl ether

ES: Enforcement Standard  
 PAL: Preventive Action Limit

Checked by: \_\_\_\_\_  
 Approved by: \_\_\_\_\_

**TABLE 6**  
**Groundwater Sample Laboratory Analytical Results**  
**Former Parkside Service Center Site**  
**Mountain, Wisconsin**

Well	Sample Date	DRO	GRO	Benzene	1,2-DCA	Ethyl-benzene	MTBE	Naphthalene	Toluene	1,2,4-TMB	1,3,5-TMB	Total Xylenes	Dissolved Lead
MW-1	4/3/2002	200	<100	<0.43	<0.54	<0.49	0.83	<1.4	<0.63	1.9	0.94	<1.45	NA
	1/28/2003	NA	NA	<0.45	NA	<0.82	<0.43	<0.89	<0.68	<0.92	<0.94	<2.47	<1.3
	5/7/2003	NA	NA	<0.3	NA	<0.6	1.3	3.1	<0.58	1.2	<0.52	<1.84	NA
	4/14/2004	NA	NA	<0.14	NA	<0.4	0.44	1.1	<0.36	0.5	<0.4	<1.1	NA
	5/18/05	NA	NA	NA	NA	NA	NA	NA	NA	NA	NA	NA	NA
MW-2	4/3/2002	900	2,700	<b>60</b>	<5.4	47	<4.9	26	150	190	76	600	NA
	1/28/2003	NA	NA	3.4	NA	44	2.0	<b>40</b>	2.0	150	30	233	<1.3
	5/7/2003	NA	NA	<b>120</b>	NA	280	4.7	<b>250</b>	610	<b>1,100</b>	<b>290</b>	3,370	NA
	4/14/2004	NA	NA	<b>77</b>	NA	270	8.6	<b>240</b>	240	<b>1,200</b>	<b>290</b>	3,040	NA
	5/18/2005	NA	NA	<b>57</b>	NA	190	6.0	<b>250</b>	94	<b>1,200</b>	<b>230</b>	2,330	NA
MW-3	4/3/2002	3,100	3,400	<b>62</b>	<5.4	56	6.5	<b>59</b>	120	260	110	510	NA
	1/28/2003	NA	NA	0.77	NA	<0.82	<0.43	4.0	<0.68	8.1	2.2	4.57	<1.3
	5/7/2003	NA	NA	<b>240</b>	NA	66	39	<b>63</b>	37	240	68	386	NA
	4/14/2004	NA	NA	<b>250</b>	NA	91	6.1	<b>62</b>	110	210	35	438	NA
	5/18/2005	NA	NA	<b>37</b>	NA	24	4.9	23	90	54	11	157	NA
MW-4	4/3/2002	170	360	<b>15</b>	<0.54	3.0	40	8.0	7.3	29	13	40	NA
	1/28/2003	NA	NA	<0.45	NA	<0.82	<0.43	<0.89	<0.68	<0.92	<0.94	<2.47	<1.3
	5/7/2003	NA	NA	<0.66	NA	<0.6	<0.58	<0.58	<0.58	<0.66	<0.52	<1.84	NA
	4/14/2004	NA	NA	<0.14	NA	<0.4	<0.36	<0.47	<0.36	<0.39	<0.4	<1.1	NA
	5/18/2005	NA	NA	NA	NA	NA	NA	NA	NA	NA	NA	NA	NA
MW-5	4/3/2002	<100	<100	2.3	<0.54	<0.49	<0.49	<1.4	<0.63	1.8	<0.72	3.5	NA
	1/28/2003	NA	NA	<0.45	NA	<0.82	<0.43	<0.89	<0.68	<0.92	<0.94	<2.47	<1.3
	5/7/2003	NA	NA	2.1	NA	<0.6	<0.58	0.9	<0.58	13	<0.52	4.43	NA
	4/14/2004	NA	NA	<0.14	NA	<0.4	<0.36	<0.47	<0.36	<0.39	<0.4	<1.1	NA
	5/18/2005	NA	NA	NA	NA	NA	NA	NA	NA	NA	NA	NA	NA
NR 140 ES	NS	NS	5	5	700	60	40	1,000	480*		10,000	15	
NR 140 PAL	NS	NS	0.5	0.5	140	12	8	200	96*		1,000	1.5	

Notes: All results are reported in ppb, unless otherwise noted

(continued)

**Bold** indicates value equals or exceeds the NR 140 Enforcement Standards.

*Italics* indicates value equals or exceeds the NR 140 Preventive Action Limit.

(\*): NR 140 Enforcement Standard and NR 140 Preventive Action Limit based on total TMB concentrations.

DRO:	Diesel Range Organics	NA:	Not Analyzed
GRO:	Gasoline Range Organics	NS:	No Standard
DCA:	Dichloroethane	ES:	Enforcement Standard
MTBE:	Methyl t-butyl ether	PAL:	Preventive Action Limit
TMB:	Trimethylbenzene	NI:	Not Installed

**TABLE 6 (Continued)**  
**Groundwater Sample Laboratory Analytical Results**  
**Former Parkside Service Center Site**  
**Mountain, Wisconsin**

Well	Sample Date	DRO	GRO	Benzene	1,2-DCA	Ethyl-benzene	MTBE	Naphthalene	Toluene	1,2,4-TMB	1,3,5-TMB	Total Xylenes	Dissolved Lead
MW-6	4/3/2002	<100	<100	<0.43	<0.54	<0.49	<0.49	<1.4	<0.63	<0.42	<0.72	<1.45	NA
	1/28/2003	NA	NA	<0.45	NA	<0.82	<0.43	<0.89	<0.68	<0.92	<0.94	<2.47	<1.3
	5/7/2003	NA	NA	1.7	NA	<0.6	<0.58	<0.58	<0.58	<0.66	<0.52	<1.84	NA
	4/14/2004	NA	NA	<0.14	NA	<0.4	<0.36	<0.47	<0.36	<0.39	<0.4	<1.1	NA
	5/18/2005	NA	NA	NA	NA	NA	NA	NA	NA	NA	NA	NA	NA
MW-7	4/3/2002	<100	<100	<0.43	<0.54	<0.49	3.2	<1.4	<0.63	<0.42	<0.72	<1.45	NA
	1/28/2003	NA	NA	<0.45	NA	<0.82	<0.43	<0.89	<0.68	<0.92	<0.94	<2.47	<1.3
	5/7/2003	NA	NA	<0.3	NA	<0.6	1.6	<0.58	<0.58	<0.66	<0.52	<1.84	NA
	4/14/2004	NA	NA	<0.14	NA	<0.4	<0.36	<0.47	<0.36	<0.39	<0.4	<1.1	NA
	5/18/2005	NA	NA	NA	NA	NA	NA	NA	NA	NA	NA	NA	NA
MW-8	4/3/2002	260	1,000	<b>38</b>	<0.54	54	13	13	2.8	41	10	180	NA
	1/28/2003	NA	NA	<b>26</b>	NA	100	6.3	<b>55</b>	3.6	170	38	383	<1.3
	5/7/2003	NA	NA	<b>61</b>	NA	64	17	23	3.2	92	15	157.9	NA
	4/14/2004	NA	NA	<b>18</b>	NA	20	6.8	4.6	1.2	11	2.3	30.6	NA
	5/18/2005	NA	NA	<b>16</b>	NA	24	3.8	23	1.3	54	15	101.8	NA
MW-9	4/3/2002	NI	NI	NI	NI	NI	NI	NI	NI	NI	NI	NI	NI
	1/28/2003	NA	NA	<0.25	<0.55	<0.53	<0.87	<0.63	<0.84	<0.69	<0.64	<1.83	<1.3
	5/7/2003	NA	NA	<0.3	NA	<0.6	<0.58	<0.58	<0.58	<0.66	<0.52	<1.84	NA
	4/14/2004	NA	NA	<0.14	NA	<0.4	<0.36	<0.47	<0.36	<0.39	<0.4	<1.1	NA
	5/18/2005	NA	NA	NA	NA	NA	NA	NA	NA	NA	NA	NA	NA
PW-1	4/3/2002	NA	NA	<0.08	<0.12	<0.08	<0.07	<0.1	<0.08	<0.11	<0.08	<0.34	NA
	1/28/2003	NA	NA	<0.45	NA	<0.82	<0.43	<0.89	<0.68	<0.92	<0.94	<2.47	NA
	5/7/2003	NA	NA	NA	NA	NA	NA	NA	NA	NA	NA	NA	NA
	4/14/2004	NA	NA	NA	NA	NA	NA	NA	NA	NA	NA	NA	NA
	5/18/2005	NA	NA	NA	NA	NA	NA	NA	NA	NA	NA	NA	NA
STREAM	4/3/2002	NA	NA	<0.43	<0.54	<0.49	<0.49	<1.4	<0.63	<0.42	<0.72	<1.45	NA
	1/28/2003	NA	NA	<0.45	NA	<0.82	<0.43	<0.89	<0.68	<0.92	<0.94	<2.47	NA
OW-1	6/25/1997	NA	1,800	<b>770</b>	NA	8.5	<b>350</b>	NA	200	11	3.6"J"	65	NA
N. SWAMP	5/7/2003	NA	NA	<0.3	NA	<0.6	<0.58	<0.58	<0.58	<0.66	<0.52	<1.84	NA
E. SWAMP	5/7/2003	NA	NA	<0.3	NA	<0.6	<0.58	<0.58	<0.58	<0.66	<0.52	<1.84	NA
NR 140 ES		NS	NS	5	5	700	60	40	1,000	480*		10,000	15
NR 140 PAL		NS	NS	0.5	0.5	140	12	8	200	96*		1,000	1.5

Notes: All results are reported in ppb, unless otherwise noted

**Bold** indicates value equals or exceeds the NR 140 Enforcement Standards.

*Italics* indicates value equals or exceeds the NR 140 Preventive Action Limit.

(\*): NR 140 Enforcement Standard and NR 140 Preventive Action Limit based on total TMB concentrations.

DRO: Diesel Range Organics

NA: Not Analyzed

GRO: Gasoline Range Organics

NS: No Standard

DCA: Dichloroethane

ES: Enforcement Standard

MTBE: Methyl t-butyl ether

PAL: Preventive Action Limit

TMB: Trimethylbenzene

NI: Not Installed

**TABLE 5**  
**Groundwater Sample PAH Laboratory Analytical Results**  
**Former Parkside Service Center Site**  
**Mountain, Wisconsin**

Parameter	MW-1	MW-2	MW-3	MW-4	MW-5	MW-6	MW-7	MW-8	MW-3	WDNR Suggested Generic RCLs for PAH	
	4/3/2002	4/3/2002	4/3/2002	4/3/2002	4/3/2002	4/3/2002	4/3/2002	4/3/2002	1/28/2003	Enforcement Standard	Preventive Action Limit
Acenaphthene	<0.106	<0.053	<0.053	<0.053	<0.053	<0.053	<0.053	<0.024	0.034	NS	NS
Acenaphthylene	<0.32	<0.16	<0.16	<0.16	<0.16	<0.16	<0.16	<0.16	<0.019	NS	NS
Anthracene	<0.048	<0.024	<0.024	<0.024	<0.024	<0.024	0.14	<0.024	<0.02	3,000	600
Benzo(a)anthracene	<0.06	<0.03	<0.03	<0.03	<0.03	<0.03	<0.03	<0.03	<0.012	NA	NA
Benzo(a)pyrene	<0.044	<0.022	<0.022	<0.022	<0.022	<0.022	<0.022	<0.022	<0.014	0.2	0.02
Benzo(b)fluoranthene	<0.072	<0.036	<0.036	<0.036	<0.036	<0.036	<0.036	<0.036	<0.013	0.2	0.02
Benzo(ghi)perylene	<0.174	<0.087	<0.087	<0.087	<0.087	<0.087	<0.087	<0.087	<0.016	NS	NS
Benzo(k)fluoranthene	<0.134	<0.067	<0.067	<0.067	<0.067	<0.067	<0.067	<0.067	<0.019	NS	NS
Indeno(1,2,3-cd)pyrene	<0.06	<0.03	<0.03	<0.03	<0.03	<0.03	<0.03	<0.03	<0.021	NS	NS
Chrysene	<0.044	<0.022	<0.022	<0.022	<0.022	<0.022	<b>0.23</b>	<0.022	<0.014	0.2	0.02
Dibenzo(a,h)anthracene	<0.072	<0.036	<0.036	<0.036	<0.036	<0.036	<0.036	<0.036	<0.016	NS	NS
Fluoranthene	<0.106	<0.053	<0.053	<0.053	<0.053	<0.053	<0.053	<0.053	0.028	400	80
Fluorene	<0.05	<0.025	<0.025	<0.025	<0.025	<0.025	<0.025	<0.025	0.033	400	80
1-Methylnaphthalene	2.2	<24	120	4.2	0.74	<0.095	<0.095	16	6	NS	NS
2-Methylnaphthalene	2	17	200	6.6	0.4	<0.96	<0.96	0.93	3.6	NS	NS
Naphthalene	1.5	32	<b>140</b>	5.9	0.72	<0.067	<0.067	<i>8.4</i>	2.1	40	8
Phenanthrene	<0.072	<0.036	<0.036	<0.036	<0.036	<0.036	0.41	<0.036	0.05	NS	NS
Pyrene	<0.26	<0.13	<0.13	<0.13	<0.13	<0.13	0.26	<0.13	0.026	250	50

Notes: Results in ppb unless otherwise noted

**BOLD** indicates value equals or exceeds the NR 140 Enforcement Standards.  
*ITALICS* indicates value equals or exceeds the NR 140 Preventive Action Limit.

PAH: Polynuclear aromatic hydrocarbons  
WDNR: Wisconsin Department of Natural Resources  
RCL: Residual contaminant level  
NS: No standard

Checked by: \_\_\_\_\_  
Approved by: \_\_\_\_\_

**TABLE 2**

**UST Removal Soil Sample  
Laboratory Analytical Results  
Former Parkside Service Center Site  
Mountain, Wisconsin  
May 13, 1998**

<b>Sampling Location</b>	<b>DRO (ppm)</b>	<b>GRO (ppm)</b>
S-1	<b>1,460</b>	<b>898</b>
S-2	<b>2,550</b>	<b>4,040</b>
S-3	<b>5,750</b>	<b>6,640</b>
WDNR Site Investigation Trigger Level	10	10

Notes: **Bold** indicates values equals or exceeds the WDNR Site Investigation Trigger Levels

UST:           Underground Storage Tank  
DRO:           Diesel range organics  
GRO:           Gasoline range organics  
ppm:           parts per million  
WDNR:         Wisconsin Department of Natural Resources

Checked by:  
Approved by: \_\_\_\_\_

**TABLE 2**  
**Soil Sample Laboratory Analytical Results**  
**Former Parkside Service Center Site**  
**Mountain, Wisconsin**

Sample	Date	Sample Depth (feet bls)	PID	DRO (ppm)	GRO (ppm)	Benzene	1,2-DCA	Ethyl-benzene	MTBE	Naphthalene	Toluene	1,2,4-TMB	1,3,5-TMB	Total Xylenes	Lead (ppm)
GP-1	12/20/01	2-4	241	23.52	13	<25	<25	<25	<25	230	<25	280	37	44	13
GP-2	12/20/01	4-6	<5	24	<100	<250	<250	<250	<250	<250	<250	550	<250	620	<6
GP-3	12/20/01	2-4	19.5	36.42	32	<25	<25	91	<25	520	<25	1,900	72	350	<6
GP-4	12/20/01	2-4	15.1	<b>360</b>	73	<25	<25	35	<25	1,100	<25	4,800	760	554	<b>68</b>
GP-5	12/20/01	2-4	<5	32	<10	<25	<25	<25	<25	<25	<25	<25	<25	46	<6
GP-6	12/20/01	2-4	210	<b>11,000</b>	140	<250	<250	1,100	<250	6,100	<250	6,500	2,500	3,800	11
GP-7	12/20/01	2-4	1,010	<b>5,500</b>	<b>3,700</b>	<b>20,000</b>	<500	<b>38,000</b>	<500	100,000	<b>140,000</b>	220,000	89,000	<b>380,000</b>	22
GP-8	12/20/01	4-6	24.2	<b>400</b>	<100	<250	<250	<250	<250	<250	<250	<250	<250	<750	9
MW-1	3/21/02	1-3	NA	<10	<10	<25	<25	<25	<25	<25	<25	72	<25	<75	NA
MW-1	3/21/02	11-13	NA	<10	<10	<25	<25	<25	<25	<25	<25	76	<25	<75	NA
MW-2	3/21/02	1-3	NA	<b>300</b>	<b>1,800</b>	<250	<250	<b>7,900</b>	<250	16,000	<b>5,300</b>	100,000	44,000	<b>100,000</b>	NA
MW-2	3/21/02	11-13	NA	<10	<10	<25	<25	<25	<25	<25	<25	<25	<25	<75	NA
NR 720 Generic Soil Standard				250	250	5.5	4.9	2,900	NS	NS	1,500	NS	NS	4,100	50

Notes: All results are reported in ppb, unless otherwise noted

(Continued)

**Bold** indicates value equals or exceeds the NR720 generic soil standard

bls: Below land surface  
 PID: Photoionization detector  
 DRO: Diesel Range Organics  
 GRO: Gasoline Range Organics  
 DCA: Dichloroethane  
 MTBE: Methyl t-butyl ether  
 TMB: Trimethylbenzene  
 NA: Not analyzed  
 NS: No standard

Checked by: \_\_\_\_\_  
 Approved by: \_\_\_\_\_

**TABLE 2 (Continued)**  
**Soil Sample Laboratory Analytical Results**  
**Former Parkside Service Center Site**  
**Mountain, Wisconsin**

Sample	Date	Sample Depth (feet bls)	PID	DRO (ppm)	GRO (ppm)	Benzene	1,2-DCA	Ethyl-benzene	MTBE	Naphthalene	Toluene	1,2,4-TMB	1,3,5-TMB	Total Xylenes	Lead (ppm)
MW-3	3/21/02	11-13	NA	<10	230	<b>860</b>	<250	<b>5,400</b>	<250	5,600	<b>8,900</b>	20,000	7,900	<b>38,000</b>	NA
MW-4	3/21/02	11-13	NA	31	23	<25	<25	100	<25	840	150	2,100	890	<b>9,100</b>	NA
MW-5	3/21/02	11-13	NA	<10	<10	<25	<25	<25	<25	<25	<25	<25	<25	<75	NA
MW-6	3/27/02	11-13	<5	<10	<10	<25	<25	<25	<25	<25	<25	<25	<25	<75	NA
MW-7	3/27/02	1-3	<5	190	<10	<25	<25	<25	<25	50	<25	<25	<25	<75	NA
MW-7	3/27/02	11-13	<5	<10	<10	<25	<25	<25	<25	<25	<25	<25	<25	<75	NA
MW-8	3/27/02	1-3	<5	43	<50	<130	<130	<130	<130	<130	<25	170	<130	1,200	NA
MW-8	3/27/02	11-13	<5	34	<10	<25	<25	<25	<25	<25	<25	29	<25	<75	NA
MW-9	11/25/02	0-2	<5	<b>350</b>	<3	<25	<25	<25	<25	<25	<25	<25	<25	<50	NA
MW-9	11/25/02	2-4	<5	<9	<3	<25	<25	<25	<25	<25	<25	<25	<25	<50	NA
HA-1	11/25/02	0-2	<5	<8.7	<3	<30	<30	<30	<30	<30	<30	<30	<30	<60	NA
HA-1	11/25/02	2-4	<5	240	11	<25	<25	<25	<25	880	<25	2,000	610	265	NA
<b>NR 720 Generic Soil Standard</b>				<b>250</b>	<b>250</b>	<b>5.5</b>	<b>4.9</b>	<b>2,900</b>	<b>NS</b>	<b>NS</b>	<b>1,500</b>	<b>NS</b>	<b>NS</b>	<b>4,100</b>	<b>50</b>

(Continued)

Notes: All results are reported in ppb, unless otherwise noted  
**Bold indicates value equals or exceeds the NR720 generic soil standard**

bls: Below land surface  
 PID: Photoionization detector  
 DRO: Diesel Range Organics  
 GRO: Gasoline Range Organics  
 DCA: Dichloroethane  
 MTBE: Methyl t-butyl ether  
 TMB: Trimethylbenzene  
 NA: Not analyzed  
 NS: No standard

Checked by: \_\_\_\_\_  
 Approved by: \_\_\_\_\_

**TABLE 2 (Continued)**  
**Soil Sample Laboratory Analytical Results**  
**Former Parkside Service Center Site**  
**Mountain, Wisconsin**

Sample	Date	Sample Depth (feet bls)	PID	DRO (ppm)	GRO (ppm)	Benzene	1,2-DCA	Ethyl-benzene	MTBE	Naphthalene	Toluene	1,2,4-TMB	1,3,5-TMB	Total Xylenes	Lead (ppm)
HA-2	6/5/03	2-4	NA	<5.6	NA	<25	NA	<25	<25	<25	<25	72	<25	<75	NA
HA-3	6/5/03	2-4	NA	7.4	NA	<25	NA	<25	<25	67	52	<25	<25	<75	NA
HA-4	6/5/03	0-2	NA	19	NA	<25	<25	<25	<25	<25	<25	<25	<25	<75	NA
<b>NR 720 Generic Soil Standard</b>				250	250	5.5	4.9	2,900	NS	NS	1,500	NS	NS	4,100	50

Notes: All results are reported in ppb, unless otherwise noted  
**Bold indicates value equals or exceeds the NR720 generic soil standard**

bls: Below land surface  
 PID: Photoionization detector      MTBE: Methyl t-butyl ether  
 DRO: Diesel Range Organics      TMB: Trimethylbenzene  
 GRO: Gasoline Range Organics      NA: Not analyzed  
 DCA: Dichloroethane      NS: No standard

Checked by: \_\_\_\_\_  
 Approved by: \_\_\_\_\_

**TABLE 3**  
**Soil Sample PAH Laboratory Analytical Results**  
**Former Parkside Service Center Site**  
**Mountain, Wisconsin**

Parameter	MW-1 (1-3)	MW-1 (11-13)	MW-2 (1-3)	MW-2 (11-13)	MW-3 (11-13)	MW-4 (11-13)	MW-5 (11-13)	WDNR Suggested Generic RCLs for PAH Compounds in Soil	
								Groundwater Pathway	Direct Contact Pathway
Acenaphthene	<41	<41	390	<41	150	44	<41	38,000	900,000
Acenaphthylene	<42	<42	82	<42	<42	<42	<42	700	18,000
Anthracene	<34	<34	200	<34	74	150	<34	3,000,000	5,000,000
Benzo(a)anthracene	<54	<54	<b>100</b>	<54	<54	<b>400</b>	<54	17,000	88
Benzo(a)pyrene	<59	<59	<59	<59	<59	<b>470</b>	<59	48,000	8.8
Benzo(b)fluoranthene	<42	<42	68	<42	85	<b>460</b>	<42	360,000	88
Benzo(ghi)perylene	<82	<82	<82	<82	<82	400	<82	6,800,000	1,800
Benzo(k)fluoranthene	<79	<79	<79	<79	<79	340	<79	870,000	880
Chrysene	<38	<38	92	<38	52	450	<38	37,000	8,800
Dibenzo(a,h)anthracene	<76	<76	<76	<76	<76	<b>100</b>	<76	38,000	8.8
Fluoranthene	<42	<42	320	<42	76	1,000	<42	500,000	600,000
Fluorene	<41	<41	280	<41	110	54	<41	100,000	600,000
Indeno(1,2,3-cd)pyrene	<69	<69	<69	<69	<69	<b>270</b>	<69	680,000	88
1-Methylnaphthalene	86	<37	18,000	46	14,000	420	<37	23,000	1,100,000
2-Methylnaphthalene	<72	<72	28,000	<72	24,000	670	<72	20,000	600,000
Naphthalene	42	<40	14,000	<40	16,000	310	<40	400	20,000
Phenanthrene	<20	<20	560	<20	160	750	<20	1,800	18,000
Pyrene	<58	<58	340	<58	100	890	<58	8,700,000	500,000

Notes: Results in ppb unless otherwise noted

**BOLD** indicates value exceeds direct contact pathway

(Continued)

PAH: Polynuclear Aromatic Hydrocarbons  
WDNR: Wisconsin Department of Natural Resources  
RCL: Residual contaminant level

Checked by: \_\_\_\_\_  
Approved by: \_\_\_\_\_

**TABLE 3 (Continued)**  
**Soil Sample PAH Laboratory Analytical Results**  
**Former Parkside Service Center Site**  
**Mountain, Wisconsin**

Parameter	MW-6 (11-13)	MW-7 (1-3)	MW-7 (11-13)	MW-8 (1-3)	MW-8 (11-13)	MW-9 (0-2)	MW-9 (2-4)	HA-1 (0-2)	HA-1 (2-4)	WDNR Suggested Generic RCLs for PAH Compounds in Soil	
										Groundwater Pathway	Direct Contact Pathway
Acenaphthene	<41	170	<41	<120	<41	60	<13	<13	<16	38,000	900,000
Acenaphthylene	<42	130	<42	<130	<42	<43	<21	<21	<26	700	18,000
Anthracene	<34	710	<34	<100	<34	140	<13	78	24	3,000,000	5,000,000
Benzo(a)anthracene	<54	<b>1,500</b>	<54	<b>370</b>	<54	<b>240</b>	<7.2	<b>310</b>	26	17,000	88
Benzo(a)pyrene	<59	<b>1,400</b>	<59	<b>380</b>	<59	<b>160</b>	<7.2	<b>450</b>	<b>33</b>	48,000	8.8
Benzo(b)fluoranthene	<42	<b>1,600</b>	<42	<b>610</b>	<42	66	<8.3	<b>390</b>	33	360,000	88
Benzo(ghi)perylene	<82	950	<82	300	<82	160	<14	350	30	6,800,000	1,800
Benzo(k)fluoranthene	<79	860	<79	360	<79	37	<11	350	33	870,000	880
Chrysene	<38	1,500	<38	530	<38	320	<8.3	360	28	37,000	8,800
Dibenzo(a,h)anthracene	<76	<b>200</b>	<76	<230	<76	<18	<8.9	<b>55</b>	<11	38,000	8.8
Fluoranthene	<42	3,500	<42	900	<42	170	<9.5	720	50	500,000	600,000
Fluorene	<41	400	<41	<120	<41	160	<7.2	13	<8.5	100,000	600,000
Indeno(1,2,3-cd)pyrene	<69	<b>610</b>	<69	<b>400</b>	<69	59	<13	<b>370</b>	33	680,000	88
1-Methylnaphthalene	55	<37	<37	<110	<37	300	<8.3	<8.3	87	23,000	1,100,000
2-Methylnaphthalene	<72	<72	<72	<220	<72	110	<8.9	<8.9	70	20,000	600,000
Naphthalene	<40	50	<40	<120	<40	<18	<8.9	<8.9	220	400	20,000
Phenanthrene	<20	2,500	<20	360	<20	760	<9.5	280	27	1,800	18,000
Pyrene	<58	3,100	<58	680	<58	1,300	<15	560	46	8,700,000	500,000

Notes: Results in ppb unless otherwise noted  
**BOLD** indicates value exceeds direct contact pathway

PAH: Polynuclear Aromatic Hydrocarbons  
WDNR: Wisconsin Department of Natural Resources  
RCL: Residual contaminant level

Checked by: \_\_\_\_\_  
Approved by: \_\_\_\_\_

**LEGEND**

--- PROPERTY

(W) POTABLE WELL

[ ] FORMER UST CAVITY


(S) SEPTIC

(⊕) MONITORING WELL

( ) GROUNDWATER NAPHTHALENE CONCENTRATION IN ppb

NS NOT SAMPLED

8.0 ISOCONCENTRATION CONTOUR

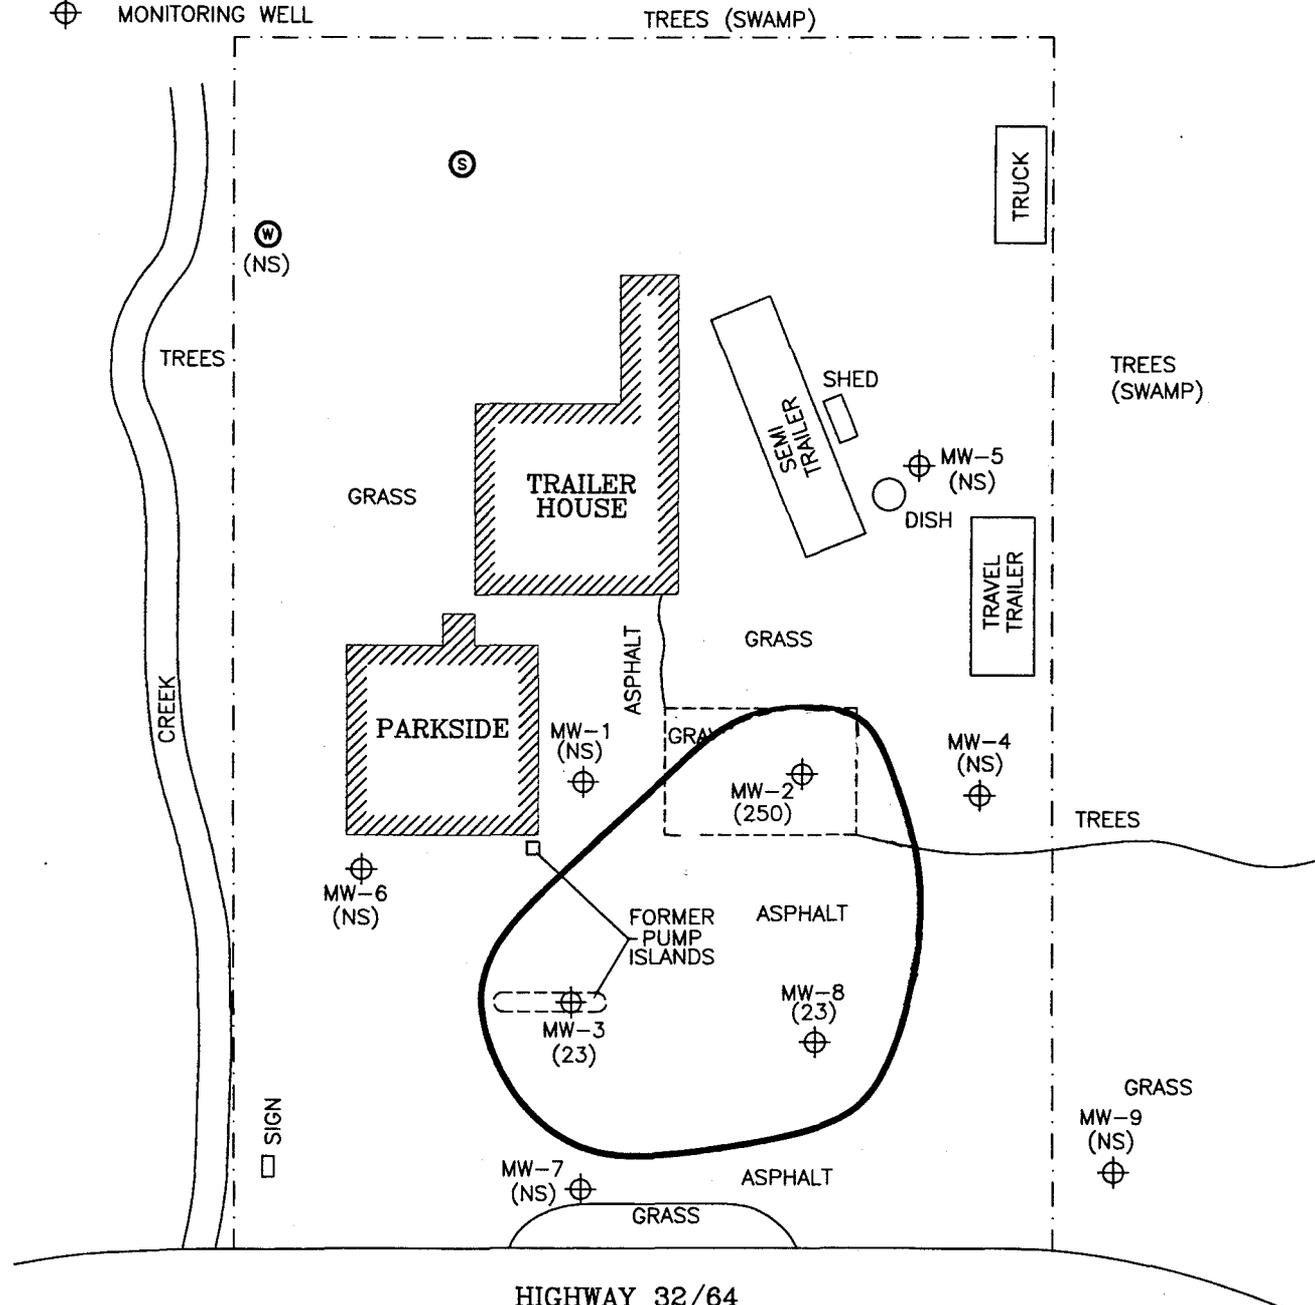

	FORMER PARKSIDE SERVICE CENTER SITE MOUNTAIN, WISCONSIN			
	<b>FIGURE 3</b> <b>GROUNDWATER DISTRIBUTION</b>			
DESIGNED BY	KFK	07/26/05	CHECKED BY	
DRAWN BY	KFK	07/26/05	APPROVED BY	
SIZE:	SCALE:	DRAWING NO.	SHEET NO.	REVISION NO.
A	1" = 30'	970198G3	1 OF 1	0

REV	DATE	BY	CHK'D	APR'VD	DESCRIPTION/ISSUE

**TABLE 1**  
**Groundwater Elevation Data**  
**Former Parkside Service Center Site**  
**Mountain, Wisconsin**

Well	Top-of-Casing Elevation	Top-of-Screen Elevation	Date	Top-of-Casing to Water (feet)	Groundwater Elevation
MW-1	962.19 *962.12* *since 4/23/04	959.59	4/3/2002	2.09	960.10
			9/27/2002	1.97	960.22
			1/28/2003	2.60	959.59
			5/7/2003	1.47	960.72
			4/14/2004	2.18	960.01
			5/18/2005	2.28	959.84
MW-2	961.78	959.18	4/3/2002	1.82	959.96
			9/27/2002	1.64	960.14
			1/28/2003	3.51	958.27
			5/7/2003	1.20	960.58
			4/14/2004	1.38	960.40
			5/18/2005	1.74	960.04
MW-3	962.03 *961.40* *since 4/23/04	959.23	4/3/2002	1.85	960.18
			9/27/2002	1.55	960.48
			1/28/2003	3.15	958.88
			5/7/2003	1.31	960.72
			4/14/2004	1.50	960.53
			5/18/2005	1.65	959.75
MW-4	961.19	958.59	4/3/2002	0.98	960.21
			9/27/2002	0.95	960.24
			1/28/2003	1.67	959.52
			5/7/2003	0.75	960.44
			4/14/2004	0.92	960.27
			5/18/2005	1.20	959.99
MW-5	962.19	959.79	4/3/2002	2.04	960.15
			9/27/2002	2.10	960.09
			1/28/2003	1.99	960.20
			5/7/2003	1.71	960.48
			4/14/2004	1.78	960.41
			5/18/2005	2.24	959.95
MW-6	961.46	959.26	4/3/2002	1.38	960.08
			9/27/2002	1.00	960.46
			1/28/2003	2.73	958.73
			5/7/2003	1.00	960.46
			4/14/2004	1.15	960.31
			5/18/2005	1.52	959.94
MW-7	961.87	959.27	4/3/2002	1.87	960.00
			9/27/2002	1.70	960.17
			1/28/2003	2.85	959.02
			5/7/2003	1.35	960.52
			4/14/2004	1.81	960.06
			5/18/2005	1.98	959.89
MW-8	961.19 *960.53* *since 4/23/04	958.29	4/3/2002	1.00	960.19
			9/27/2002	0.96	960.23
			1/28/2003	1.65	959.54
			5/7/2003	0.60	960.59
			4/14/2004	0.90	960.29
			5/18/2005	0.92	959.61
MW-9	961.79	959.89	4/3/2002	NI	NI
			9/27/2002	NI	NI
			1/28/2003	2.30	959.49
			5/7/2003	1.35	960.44
			4/14/2004	1.43	960.36
			5/18/2005	1.77	960.02


Notes: Elevations are in feet above mean sea level  
 NI: Not installed

**LEGEND**

-  POTABLE WELL
-  FORMER UST CAVITY
-  MONITORING WELL
-  SEPTIC
-  ELEVATION IN FEET ABOVE MSL
-  NOT MEASURED
-  960.00 ISOELEVATION CONTOUR

NOTES: MW-2 & MW-3 WERE NOT USED IN THE DEVELOPMENT OF THE POTENTIOMETRIC SURFACE DUE TO THE PRESENCE OF FILL MATERIALS.

HYDRAULIC GRADIENT  $dh/dl = 0.01ft/ft$

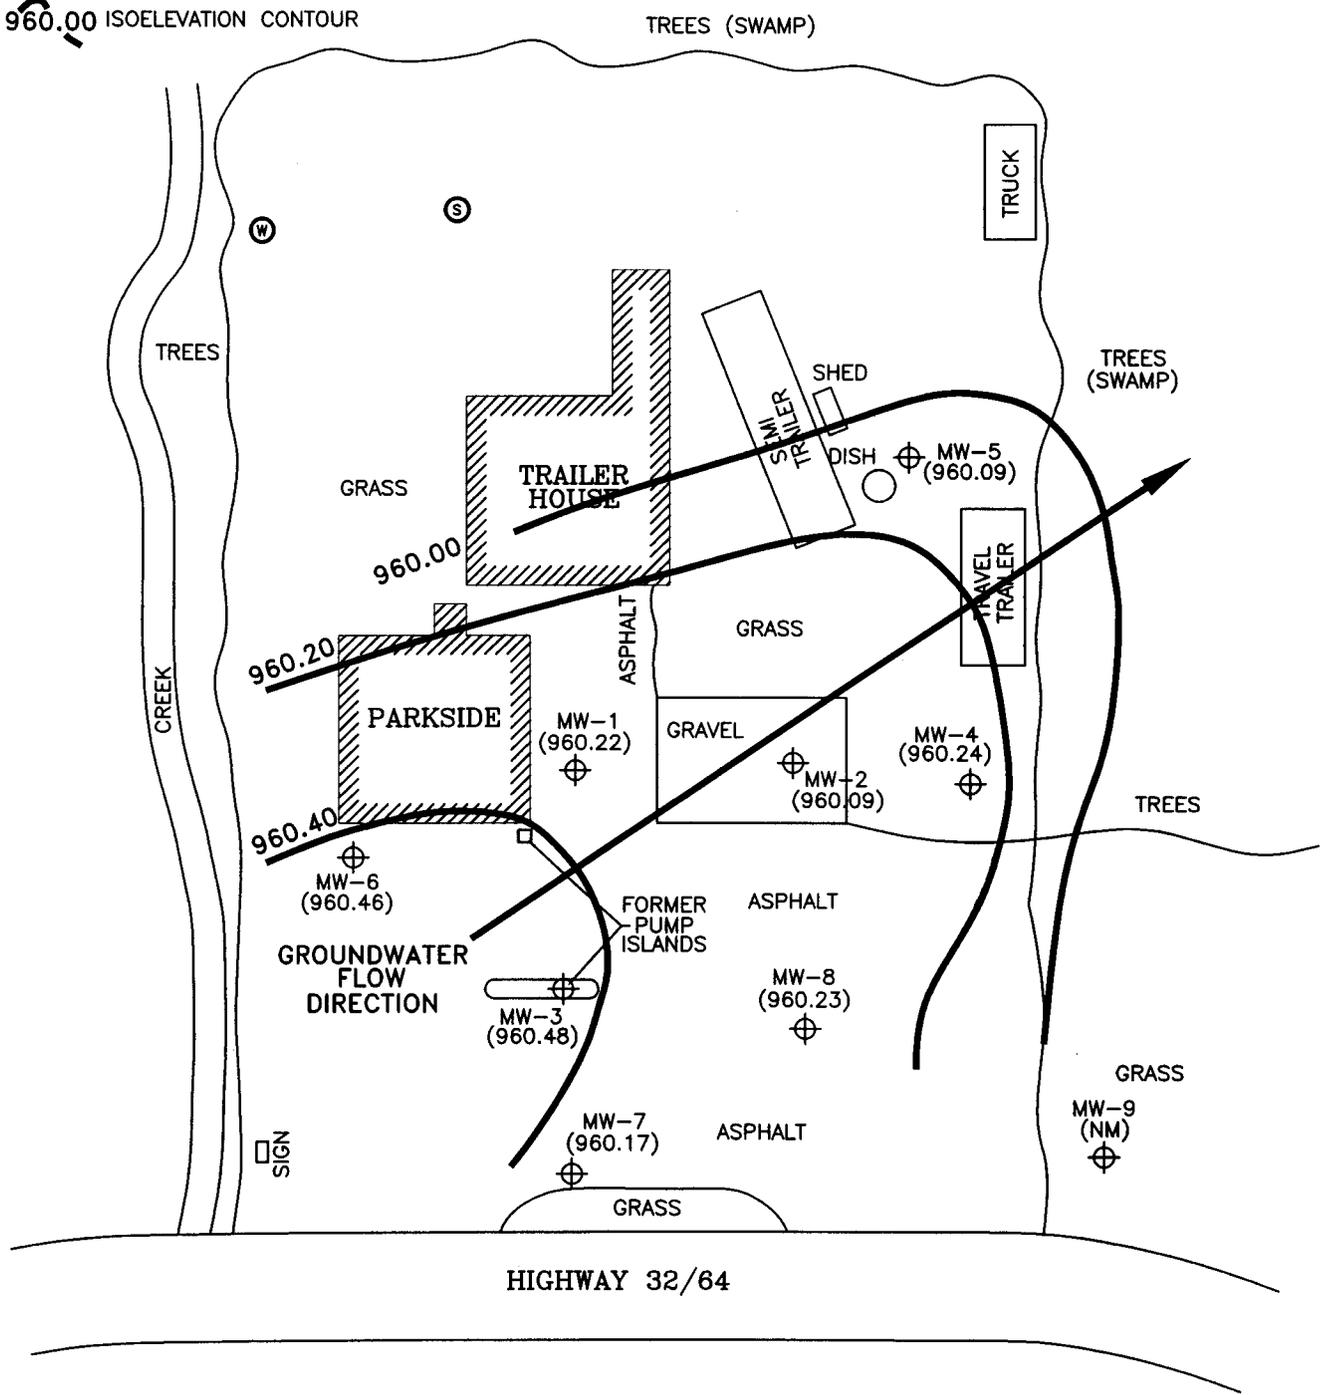


 <b>Shaw E &amp; I, Inc.</b>	FORMER PARKSIDE SERVICE CENTER SITE MOUNTAIN, WISCONSIN			
	<b>FIGURE 6</b> <b>POTENTIOMETRIC SURFACE</b> (09/27/02)			
DESIGNED BY	BFB	02/07/03	CHECKED BY	
DRAWN BY	KFK	12/06/04	APPROVED BY	
SIZE:	SCALE:	DRAWING NO.	SHEET NO.	REVISION NO.
A	1" = 30'	970198.106	1 OF 1	0

REV	DATE	BY	CHK'D	APPR'D	DESCRIPTION/ISSUE

**LEGEND**

- ⊙ POTABLE WELL
- FORMER UST CAVITY
- ⊕ MONITORING WELL
- ⊙ SEPTIC
- ( ) ELEVATION IN FEET ABOVE MSL
- 960.00 ISOELEVATION CONTOUR

NOTES: MW-2 & MW-3 WERE NOT USED IN THE DEVELOPMENT OF THE POTENTIOMETRIC SURFACE DUE TO THE PRESENCE OF FILL MATERIALS.  
 HYDRAULIC GRADIENT  $dh/dl = 0.01ft/ft$

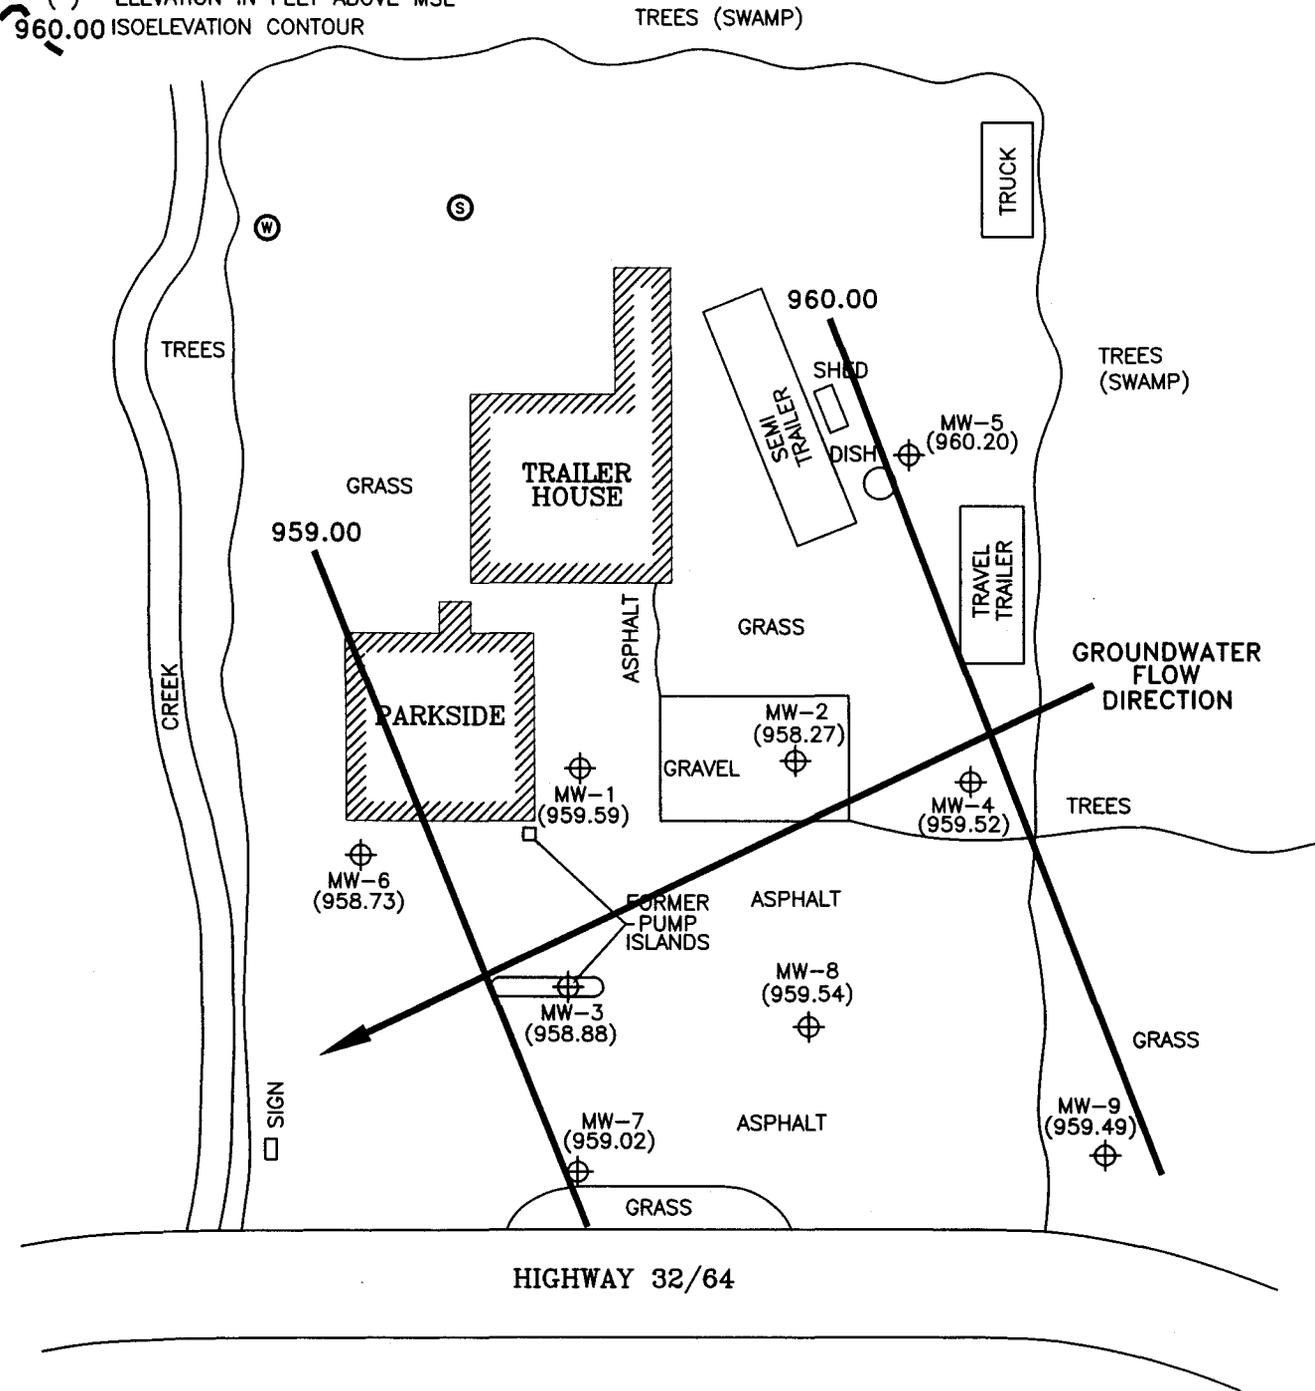


REV	DATE	BY	CHK'D	APPR'VD	DESCRIPTION/ISSUE

<p>Shaw E &amp; I, Inc.</p>	FORMER PARKSIDE SERVICE CENTER SITE MOUNTAIN, WISCONSIN			
	<p>FIGURE 7 POTENTIOMETRIC SURFACE (01/28/03)</p>			
DESIGNED BY	BFB	02/07/03	CHECKED BY	
DRAWN BY	KFK	12/06/04	APPROVED BY	
SIZE:	SCALE:	DRAWING NO.	SHEET NO.	REVISION NO.
A	1" = 30'	970198.107	1 OF 1	0

**LEGEND**

- ⊙ POTABLE WELL
- FORMER UST CAVITY
- ⊕ MONITORING WELL
- ⊙ SEPTIC
- ( ) ELEVATION IN FEET ABOVE MSL
- 960.00 ISOELEVATION CONTOUR

NOTES: MW-2 & MW-3 WERE NOT USED IN THE DEVELOPMENT OF THE POTENTIOMETRIC SURFACE DUE TO THE PRESENCE OF FILL MATERIALS.  
 HYDRAULIC GRADIENT  $dh/dl = 0.01ft/ft$

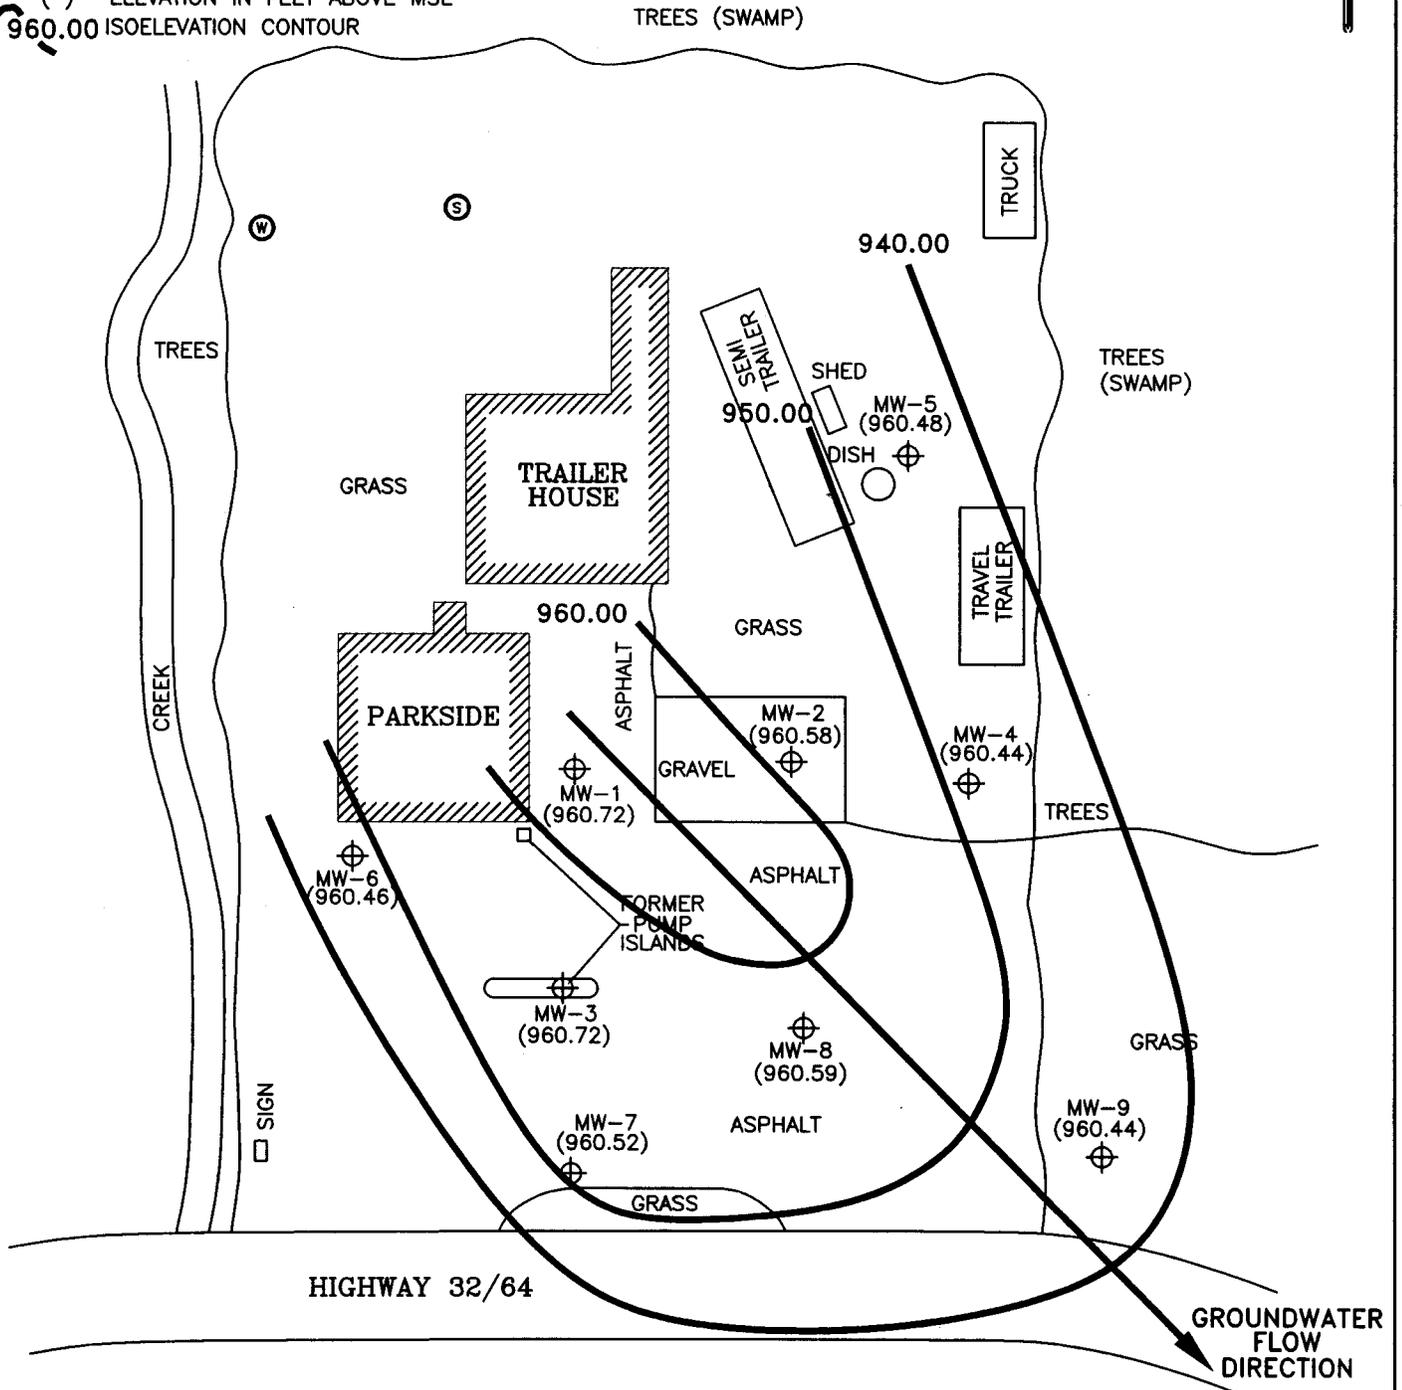


<p><b>Shaw E &amp; I, Inc.</b></p>		FORMER PARKSIDE SERVICE CENTER SITE MOUNTAIN, WISCONSIN			
		<p align="center"><b>FIGURE 8</b>                  POTENTIOMETRIC SURFACE                  (05/07/03)</p>			
DESIGNED BY	BFB	02/07/03	CHECKED BY		
DRAWN BY	KFK	12/06/04	APPROVED BY		
SIZE:	SCALE:	DRAWING NO.	SHEET NO.	REVISION NO.	
A	1" = 30'	970198.108	1 OF 1	0	

REV	DATE	BY	CHK'D	APR'VD	DESCRIPTION/ISSUE

**LEGEND**

- PROPERTY
- ⊙ POTABLE WELL
- FORMER UST CAVITY
- ⊙ SEPTIC
- ⊕ MONITORING WELL

( ) GROUNDWATER ELEVATION IN FEET ABOVE MSL  
 960.0 ISOELEVATION CONTOUR

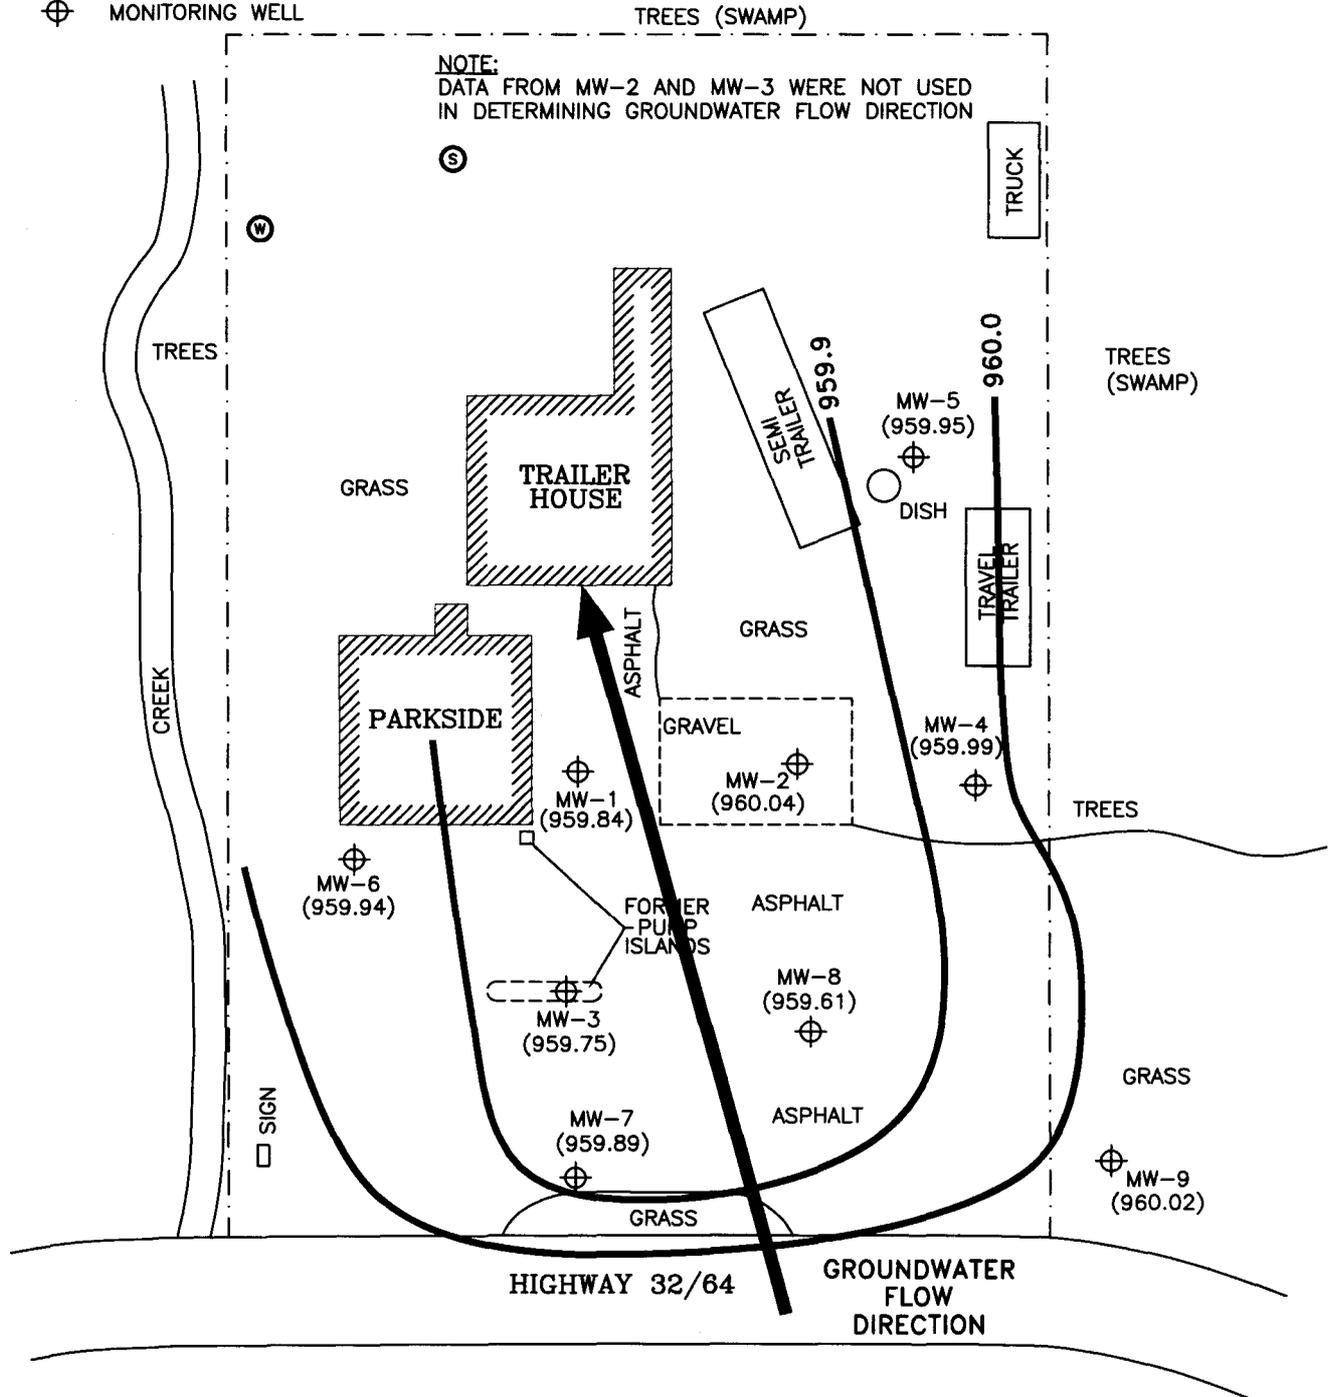


REV	DATE	BY	CHK'D	APPR'D	DESCRIPTION/ISSUE

 <b>Shaw E &amp; I, Inc.</b>	FORMER PARKSIDE SERVICE CENTER SITE MOUNTAIN, WISCONSIN			
	<b>FIGURE 5</b> POTENTIOMETRIC SURFACE (05/18/05)			
DESIGNED BY	KFK	07/28/05	CHECKED BY	
DRAWN BY	KFK	07/28/05	APPROVED BY	
SIZE:	SCALE:	DRAWING NO.	SHEET NO.	REVISION NO.
A	1" = 30'	970198G52	1 OF 1	0

**LEGEND**

- - - PROPERTY
- ⊙ POTABLE WELL
- FORMER UST CAVITY
- ⊙ SEPTIC
- GEOPROBE BORING LOCATION
- ⊕ HAND AUGER LOCATION
- ⊕ MONITORING WELL

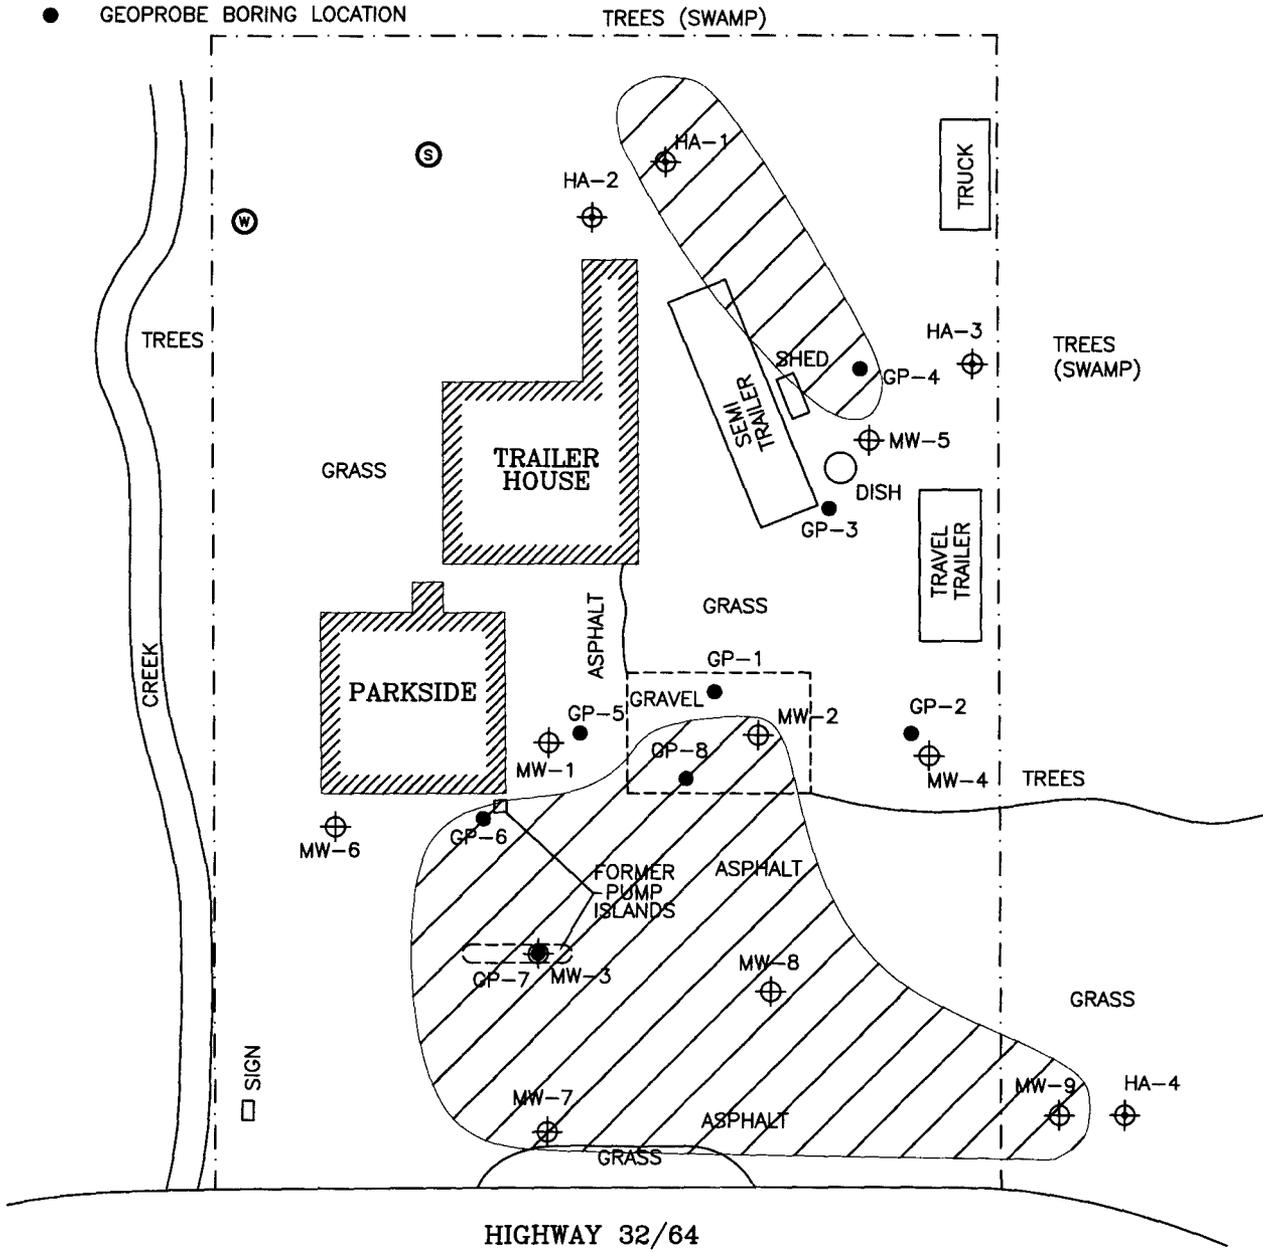

Areal extent of residual soil contamination that exceeds generic residual contaminant levels.


HIGHWAY 32/64

 <b>Shaw E &amp; I, Inc.</b>	FORMER PARKSIDE SERVICE CENTER SITE MOUNTAIN, WISCONSIN			
	GIS FIGURE RESIDUAL SOIL CONTAMINATION			
DESIGNED BY	KFK	07/26/05	CHECKED BY	
DRAWN BY	KMZ	09/12/06	APPROVED BY	<i>MB</i> 9/12/06
SIZE:	SCALE:	DRAWING NO.	SHEET NO.	REVISION NO.
A	1" = 30'	970198G6	1 OF 1	0

REV	DATE	BY	CHK'D	APRVD	DESCRIPTION/ISSUE


**LEGEND**

- ⊙ POTABLE WELL
- ⊙ SEPTIC
- FORMER UST CAVITY
- ⊕ HAND AUGER BORING
- GEOPROBE BORING LOCATION
- ⊕ MONITORING WELL

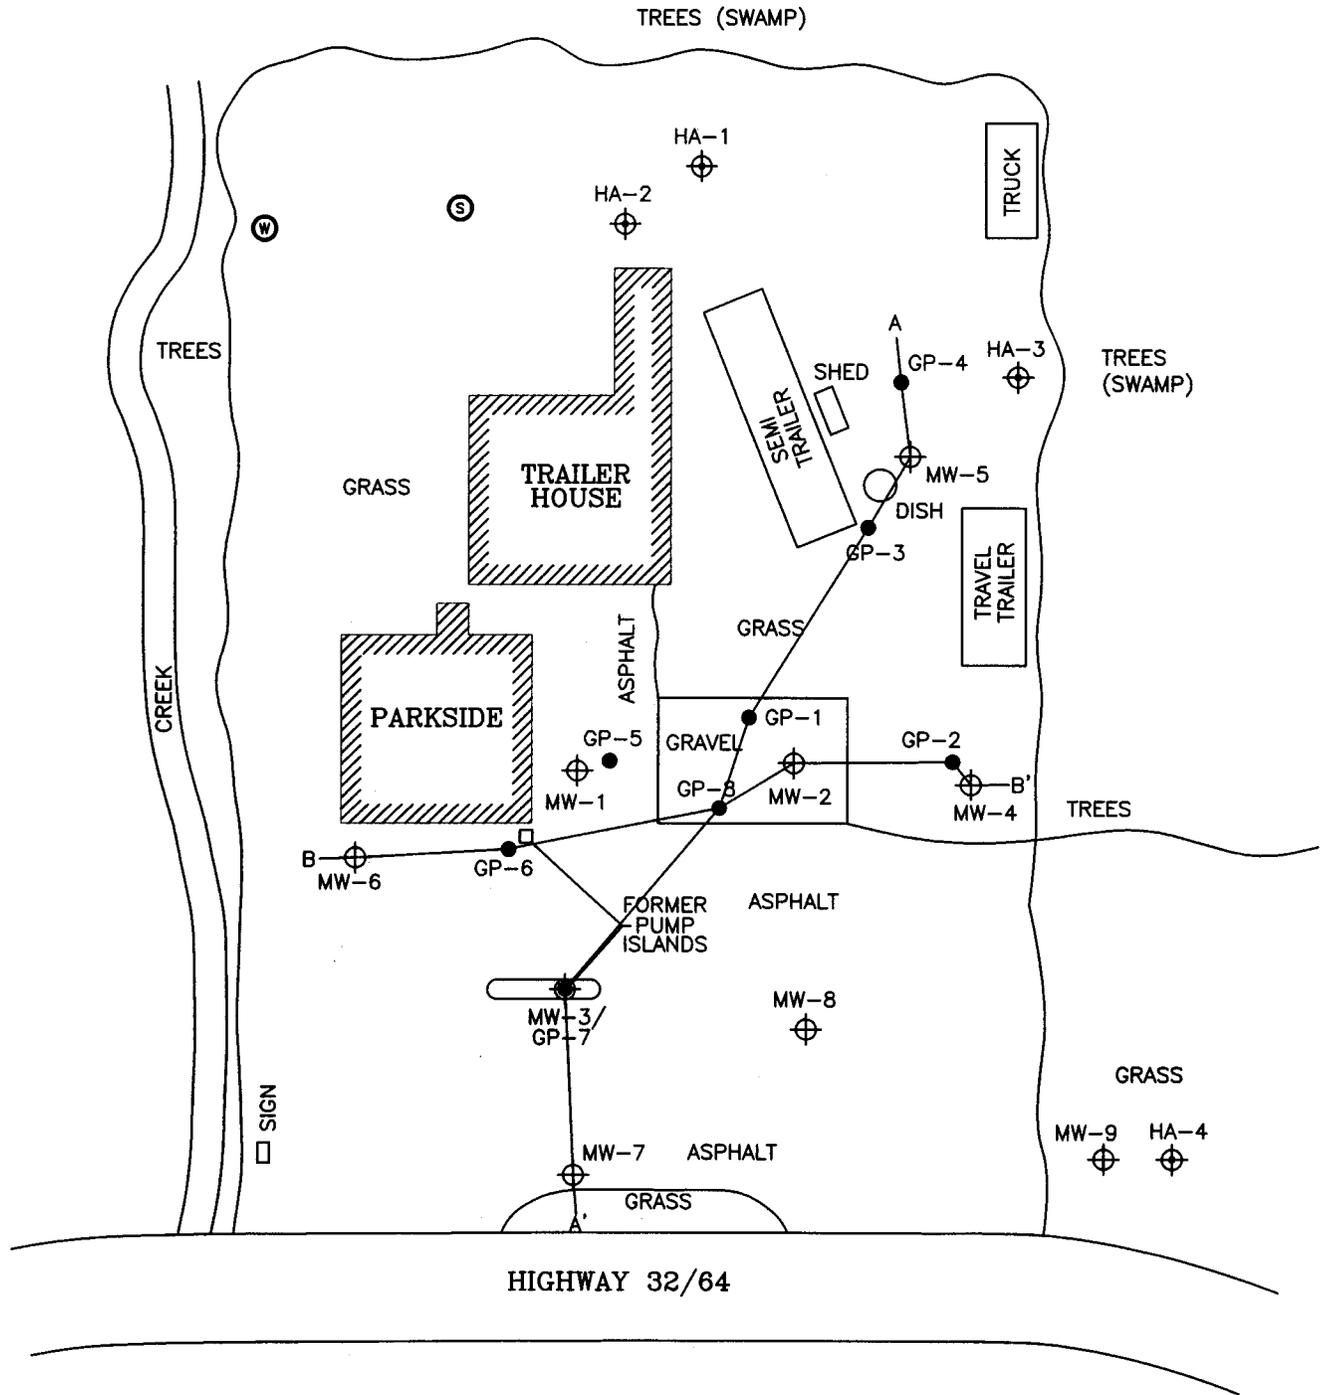

REV	DATE	BY	CHK'D	APPROV'D	DESCRIPTION/ISSUE

<p><b>Shaw</b> Shaw E &amp; I, Inc.</p>	FORMER PARKSIDE SERVICE CENTER SITE MOUNTAIN, WISCONSIN			
	FIGURE 3 GEOLOGIC CROSS SECTION PLAN VIEW			
DESIGNED BY	DFB	02/07/03	CHECKED BY	
DRAWN BY	KFK	12/06/04	APPROVED BY	
SIZE:	SCALE:	DRAWING NO.	SHEET NO.	REVISION NO.
A	1" = 30'	970198.103	1 OF 1	0

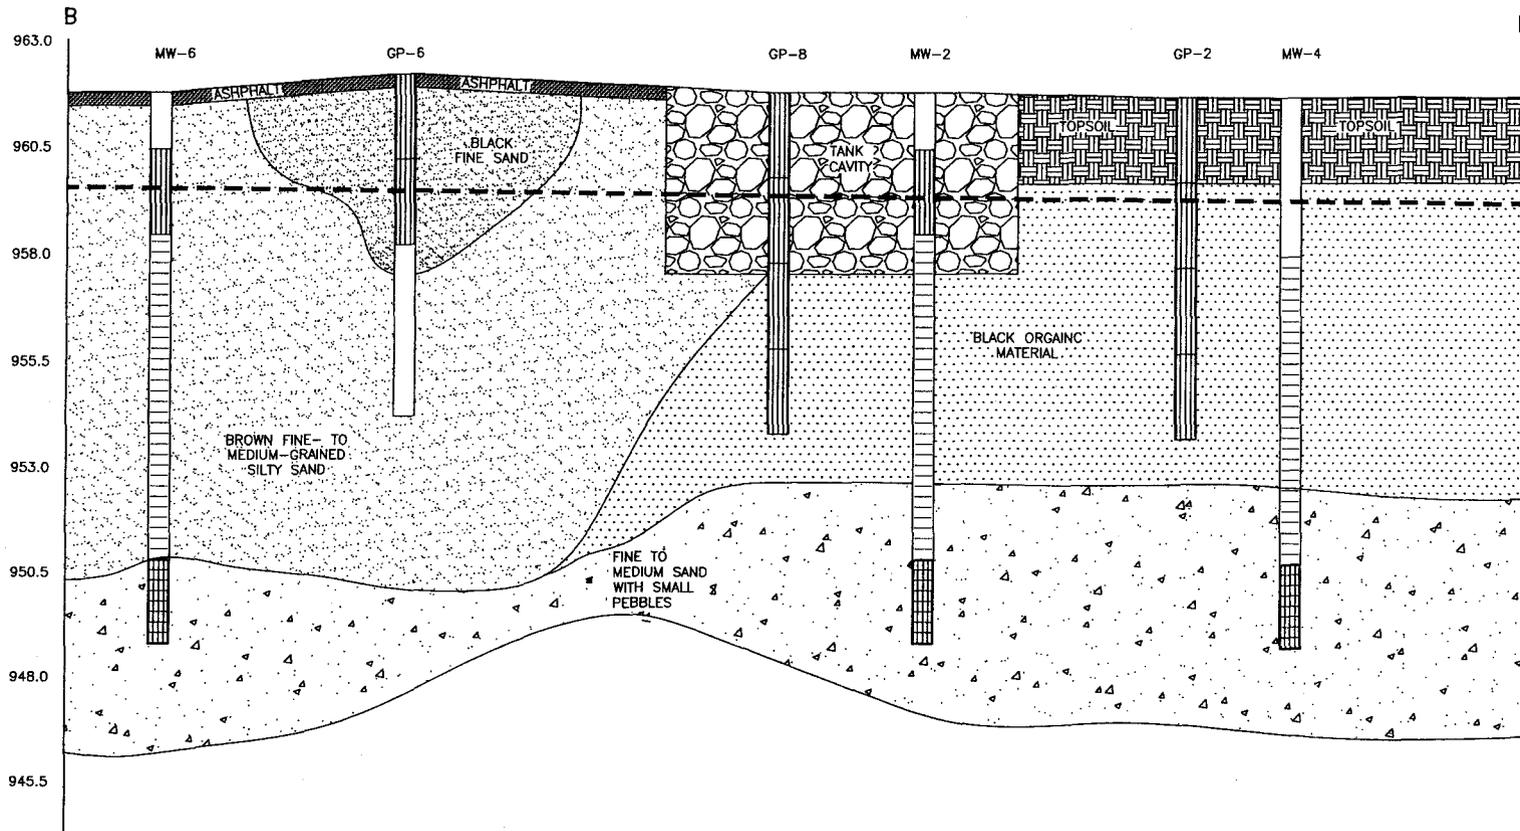

**LEGEND**



SAMPLE INTERVAL

BLACK ORGANIC MATERIAL



SCREENED INTERVAL


--- GROUNDWATER ELEVATION (05/07/03)

**SCALE**

HORIZONTAL 1" = 10'

VERTICAL 1" = 2.5'

		790 Marvella Lane Green Bay, WI 54304 (920) 497-8910	
		REV. NO.:	DRAWING DATE: 02/11/03
<b>GEOLOGIC CROSS-SECTION</b> B-B'			
SITE:		FORMER PARKSIDE SERVICE CENTER SITE	
LOCATION:		MOUNTAIN, WISCONSIN	
DESIGNED:	DETAILED:	PROJECT NO.:	FIGURE:
BFB	BFB	970198	5
		PM:	MOL
		PE/RG:	

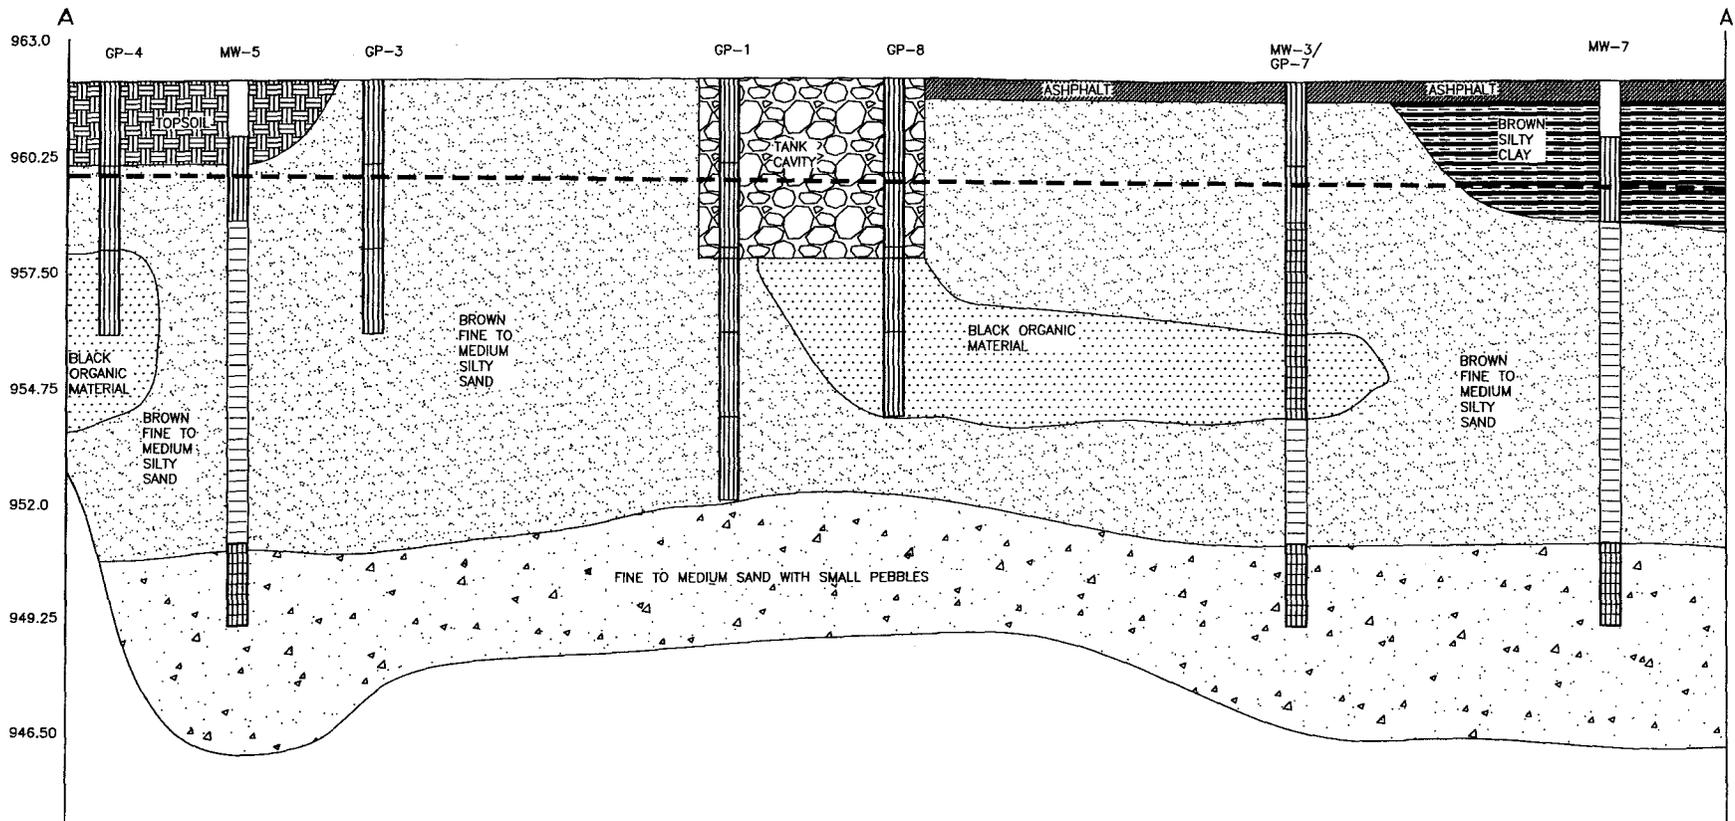

963.0  
960.25  
957.50  
954.75  
952.0  
949.25  
946.50

**LEGEND**



SAMPLE INTERVAL



SCREENED INTERVAL

--- GROUNDWATER ELEVATION (05/07/03)

**SCALE**

HORIZONTAL 1" = 10'  
VERTICAL 1" = 2.75'

		790 Marvella Lane Green Bay, WI 54304 (920) 497-8910	
		REV. NO.:	ACAD FILE:
DRAWING DATE:	970198.104		
<b>GEOLOGIC CROSS-SECTION</b> A-A'			
SITE:		FORMER PARKSIDE SERVICE CENTER SITE	
LOCATION:		MOUNTAIN, WISCONSIN	
DESIGNED:	PM:		
BFB	MOL		
PE/RG:			
DESIGNED:	PROJECT NO.:		
BFB	970198		
FIGURE:			
4			

## CERTIFICATE OF LEGAL DESCRIPTION


The legal description provided below is a true and accurate description of the property located at 13946 State Highway 32-64, Village of Mountain, Oconto County, Wisconsin.

A part of the SW  $\frac{1}{4}$  of the NW  $\frac{1}{4}$  of Section 11, Township 31 North, Range 16 East, in the Village of Mountain, Oconto County, Wisconsin, more particularly described as follows to-wit: Commencing at the NE corner of Lot 5, Block 3 of Frost Addition to the Village of Mountain; thence 44° East a distance of 177 feet to the iron pipe on the East side of the Town Creek in the SW  $\frac{1}{4}$  of the NW  $\frac{1}{4}$  Section 11, Township 31 North, Range 16 East, which is the point of beginning, thence continuing on a bearing of South 44° East a distance of 171 feet to an iron pipe, thence South 46° 36 minutes West a distance of 124.8 feet to the town road right of way, thence North 43° and 30 minutes West along the road right of way a distance of 90 feet to the Town Creek, thence Northeasterly along the town creek a distance of 153 feet more or less to the point of beginning. Containing 0.40 hundredths of an acre more or less. Above described property being part of Outlot C, Frosts Addition to the Village of Mountain.

That part of Outlot C in the Village of Mountain, Commencing at the Southwest corner of Lot one (1) in Block Three (3) of Frost Addition to the Village of Mountain, thence running Northeast 125 feet along South line along said lot; thence running Southeast about 15 feet to the Town Creek, thence running South about 161 feet along said Creek to Highway 32, thence northerly along said Highway 78 feet to point of beginning.

PARCEL NUMBER: 004-77-11077P;C4  
029-7711079OLC6

  
\_\_\_\_\_  
Signature

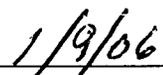  
\_\_\_\_\_  
Date

## GEOGRAPHIC POSTIONING

The Geographic Position of the contaminated site boundary based upon the WTM91 Interactive Map is 640124, 524512 and 640087, 524505.